

 $01 \frac{\text{BUILDING SECTION - PARKING GARAGE}}{1/16" = 1'-0"}$



HUNTER ROBERTS CONSTRUCTION GROUP LLC 55 Water Street, New York, NY 10041 212.699.4749

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MARVEL ARCHITECTS 145 Hudson Street, New York, NY 10013 212.616.0420

THORNTON TOMASETTI 51 Madison Avenue, New York, NY 10010 917.661.7800

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JAROS, BAUM & BOLLES / LIGHTBOX STUDIOS 80 Pine Street New York, NY 10015 212.530.9300

JFK&M ENGINEERS, LLP 134 West 37th Street New York, NY 10018 212.792.8700

REVISION DESCRIPTION DATE

PROJECT: NYC BBJ

QUEENS GARAGE & COMMUNITY SPACE

80-25 126th St, Kew Gardens, NY 11415

TECHNICAL DRAWINGS

PROJECT RORTH

KEY PLAN:

DRAWING TITLE:


BUILDING SECTION D.D

SCALE: 1/16" = 1'-0" DATE: SEPTEMBER 18, 2020


SEAL:

DRAWING NUMBER:
A-303

DRAWING ORDER:

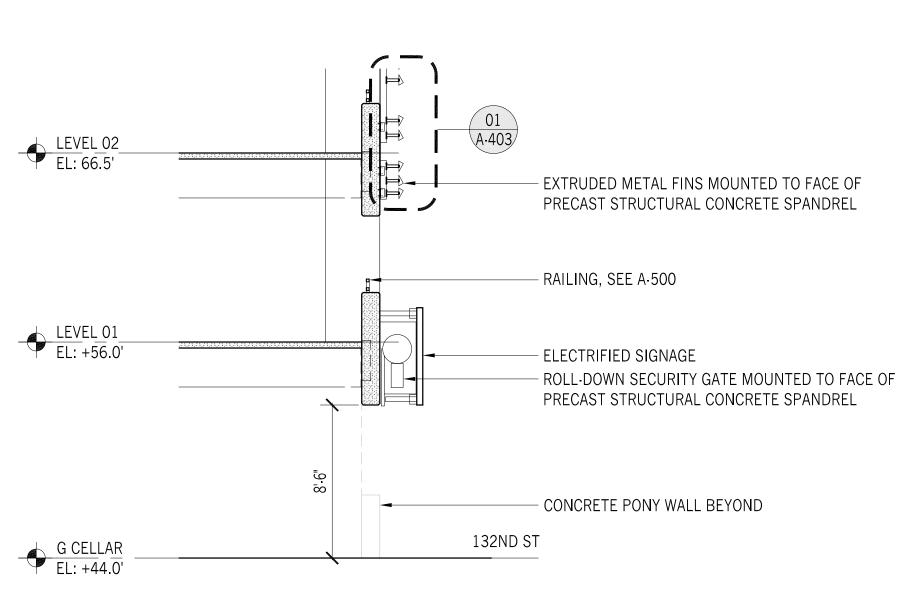

 $02 \frac{\text{ENLARGED SECTION} - 132ND GARAGE ENTRY}{3/16" = 1' \cdot 0"}$

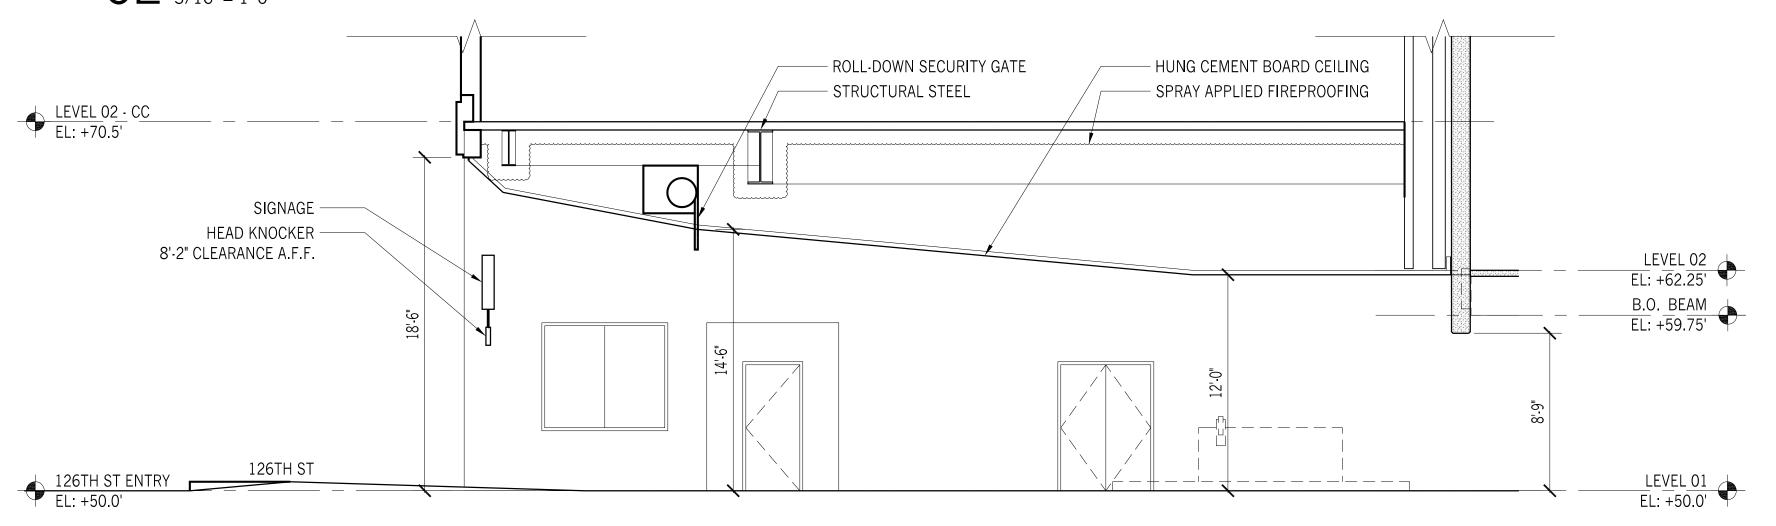

Department of Design and Construction

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212.530.9300

JFK&M ENGINEERS, LLP 134 West 37th Street New York, NY 10018 212.792.8700

REVISION	DESCRIPTION	DATE

ROJECT: NYC BBJ

QUEENS GARAGE & COMMUNITY SPACE

80-25 126th St, Kew Gardens, NY 11415

TECHNICAL DRAWINGS

PROJECT (ROAD)

DRAWING TITLE:

KEY PLAN:

ENLARGED SECTION -GARAGE ENTRANCES

SCALE: 3/16" = 1'-0" DATE: SEPTEMBER 18, 2020


SEAL:


DRAWING NUMBER:


DRAWING ORDER:

63 of 205

 $01 \ \frac{\text{ENLARGED SECTION - 126TH GARAGE ENTRY}}{3/16" = 1' \cdot 0"}$

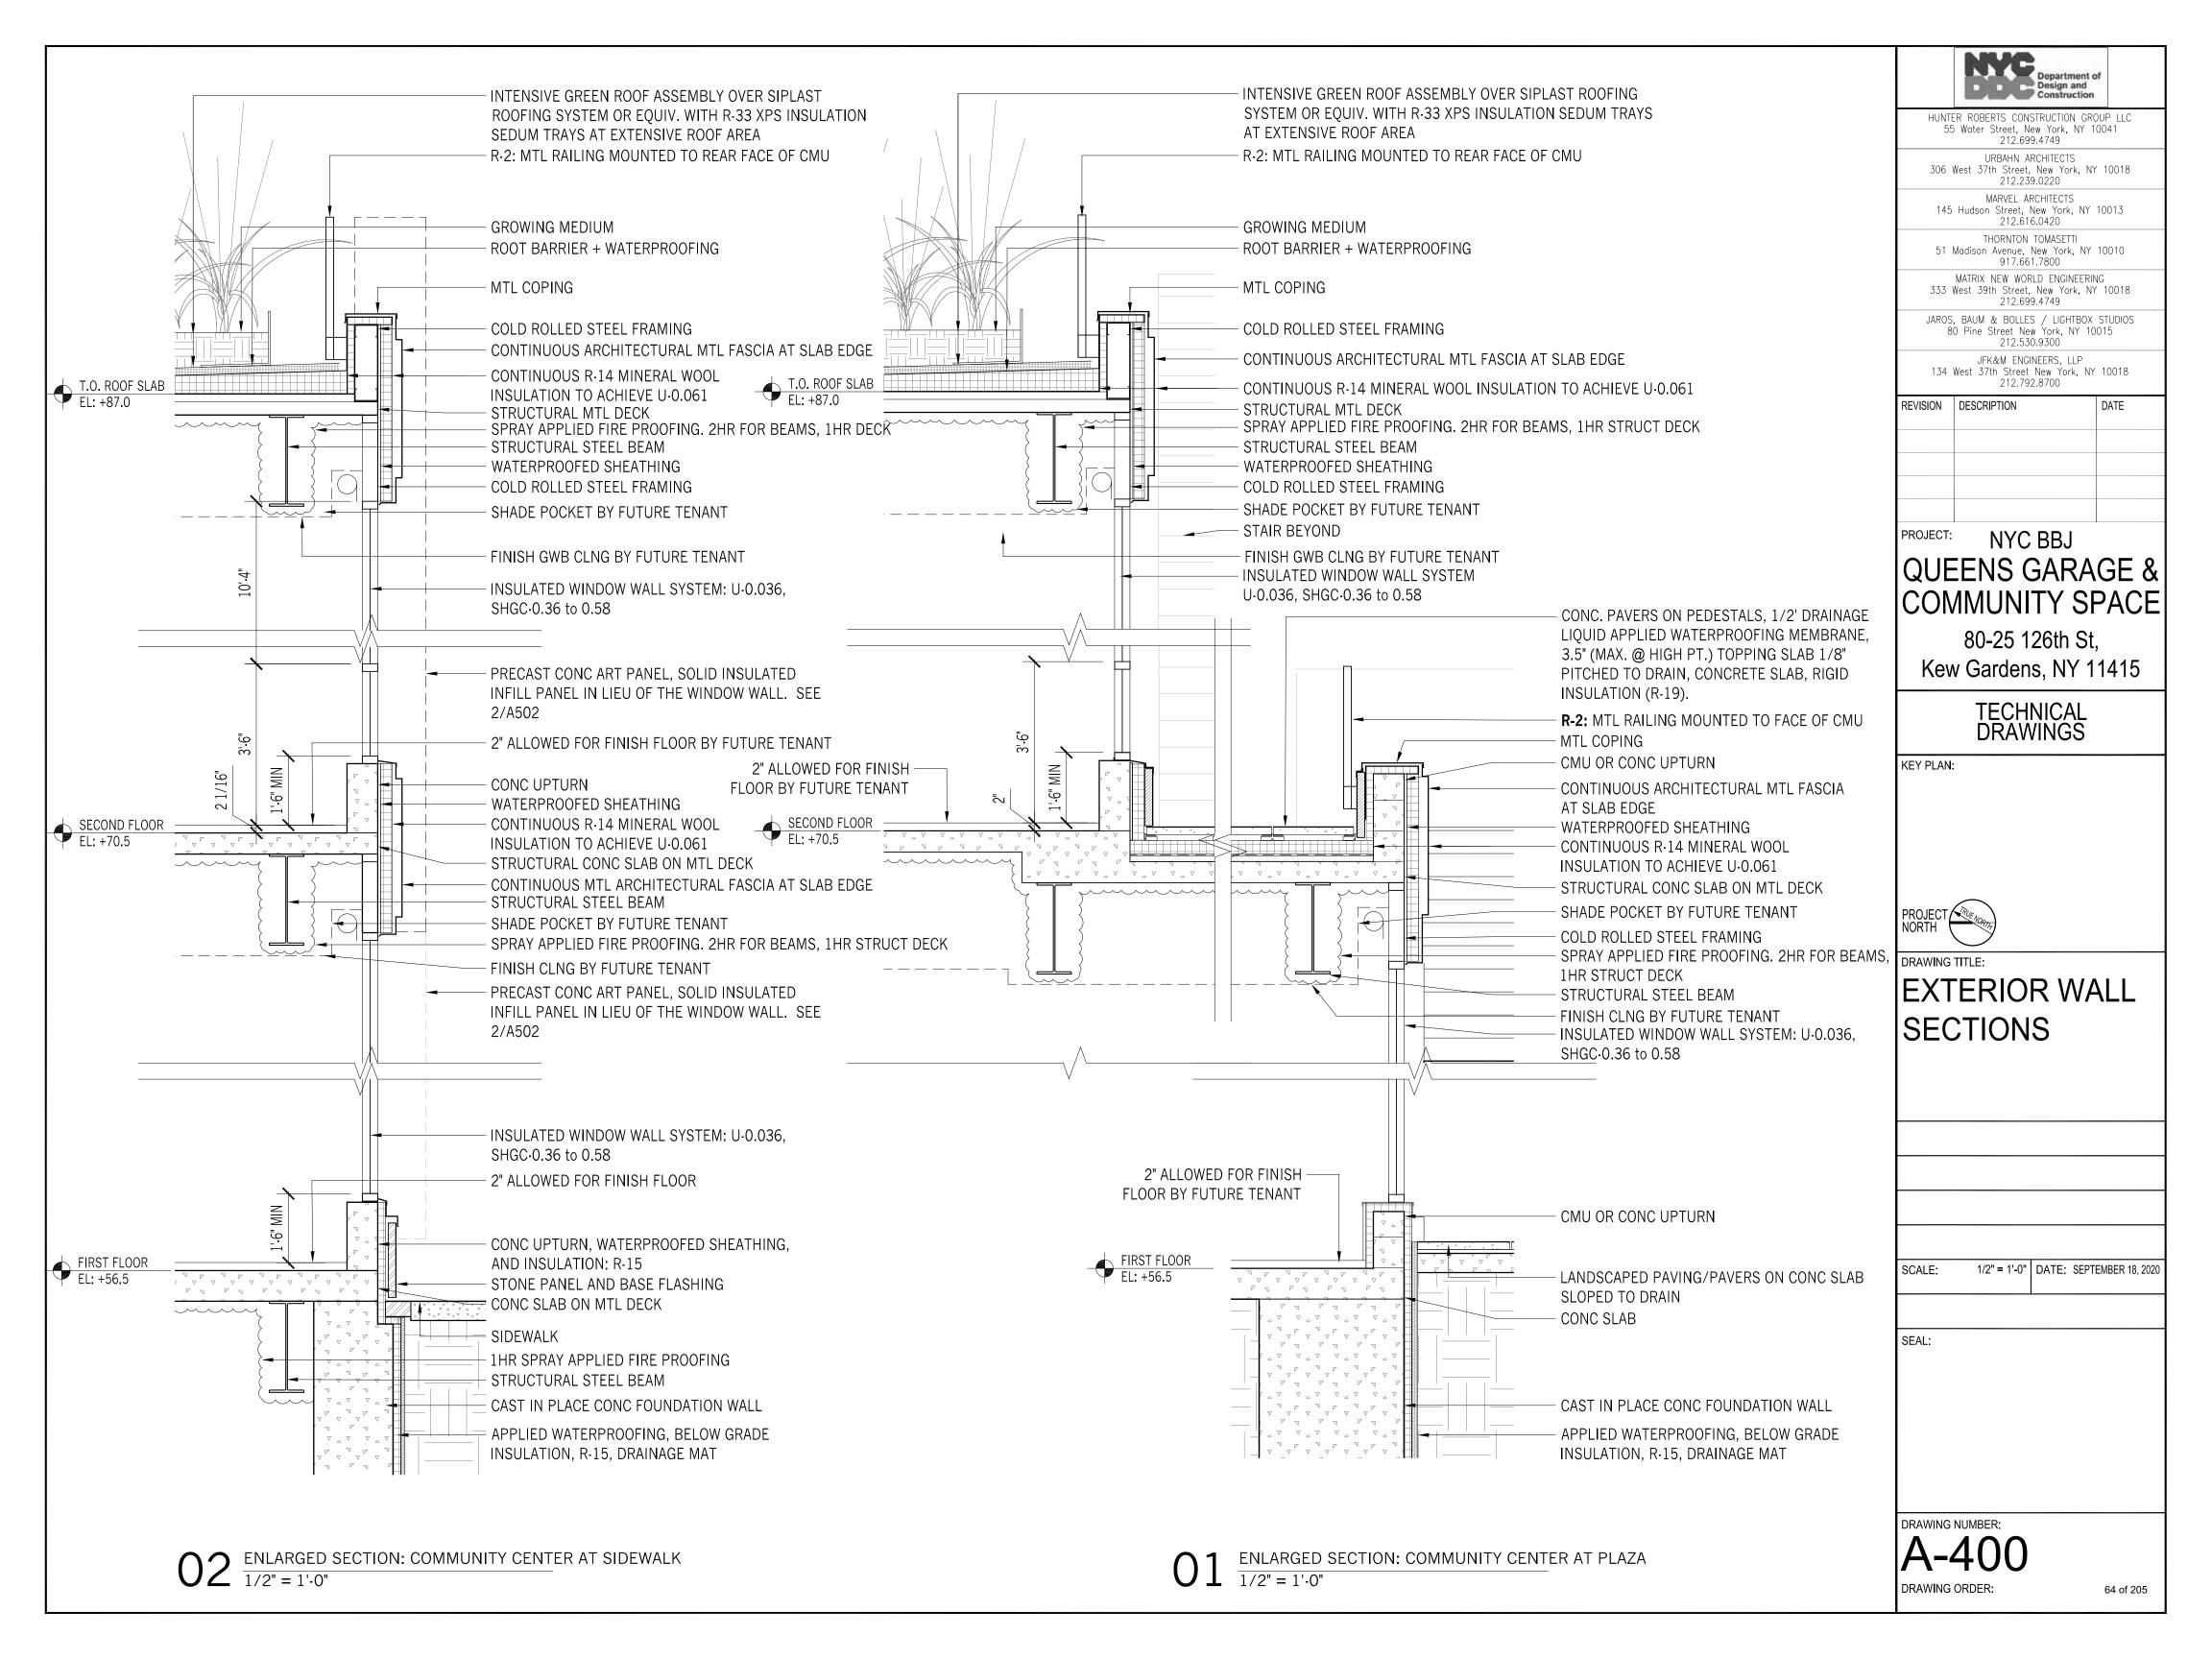

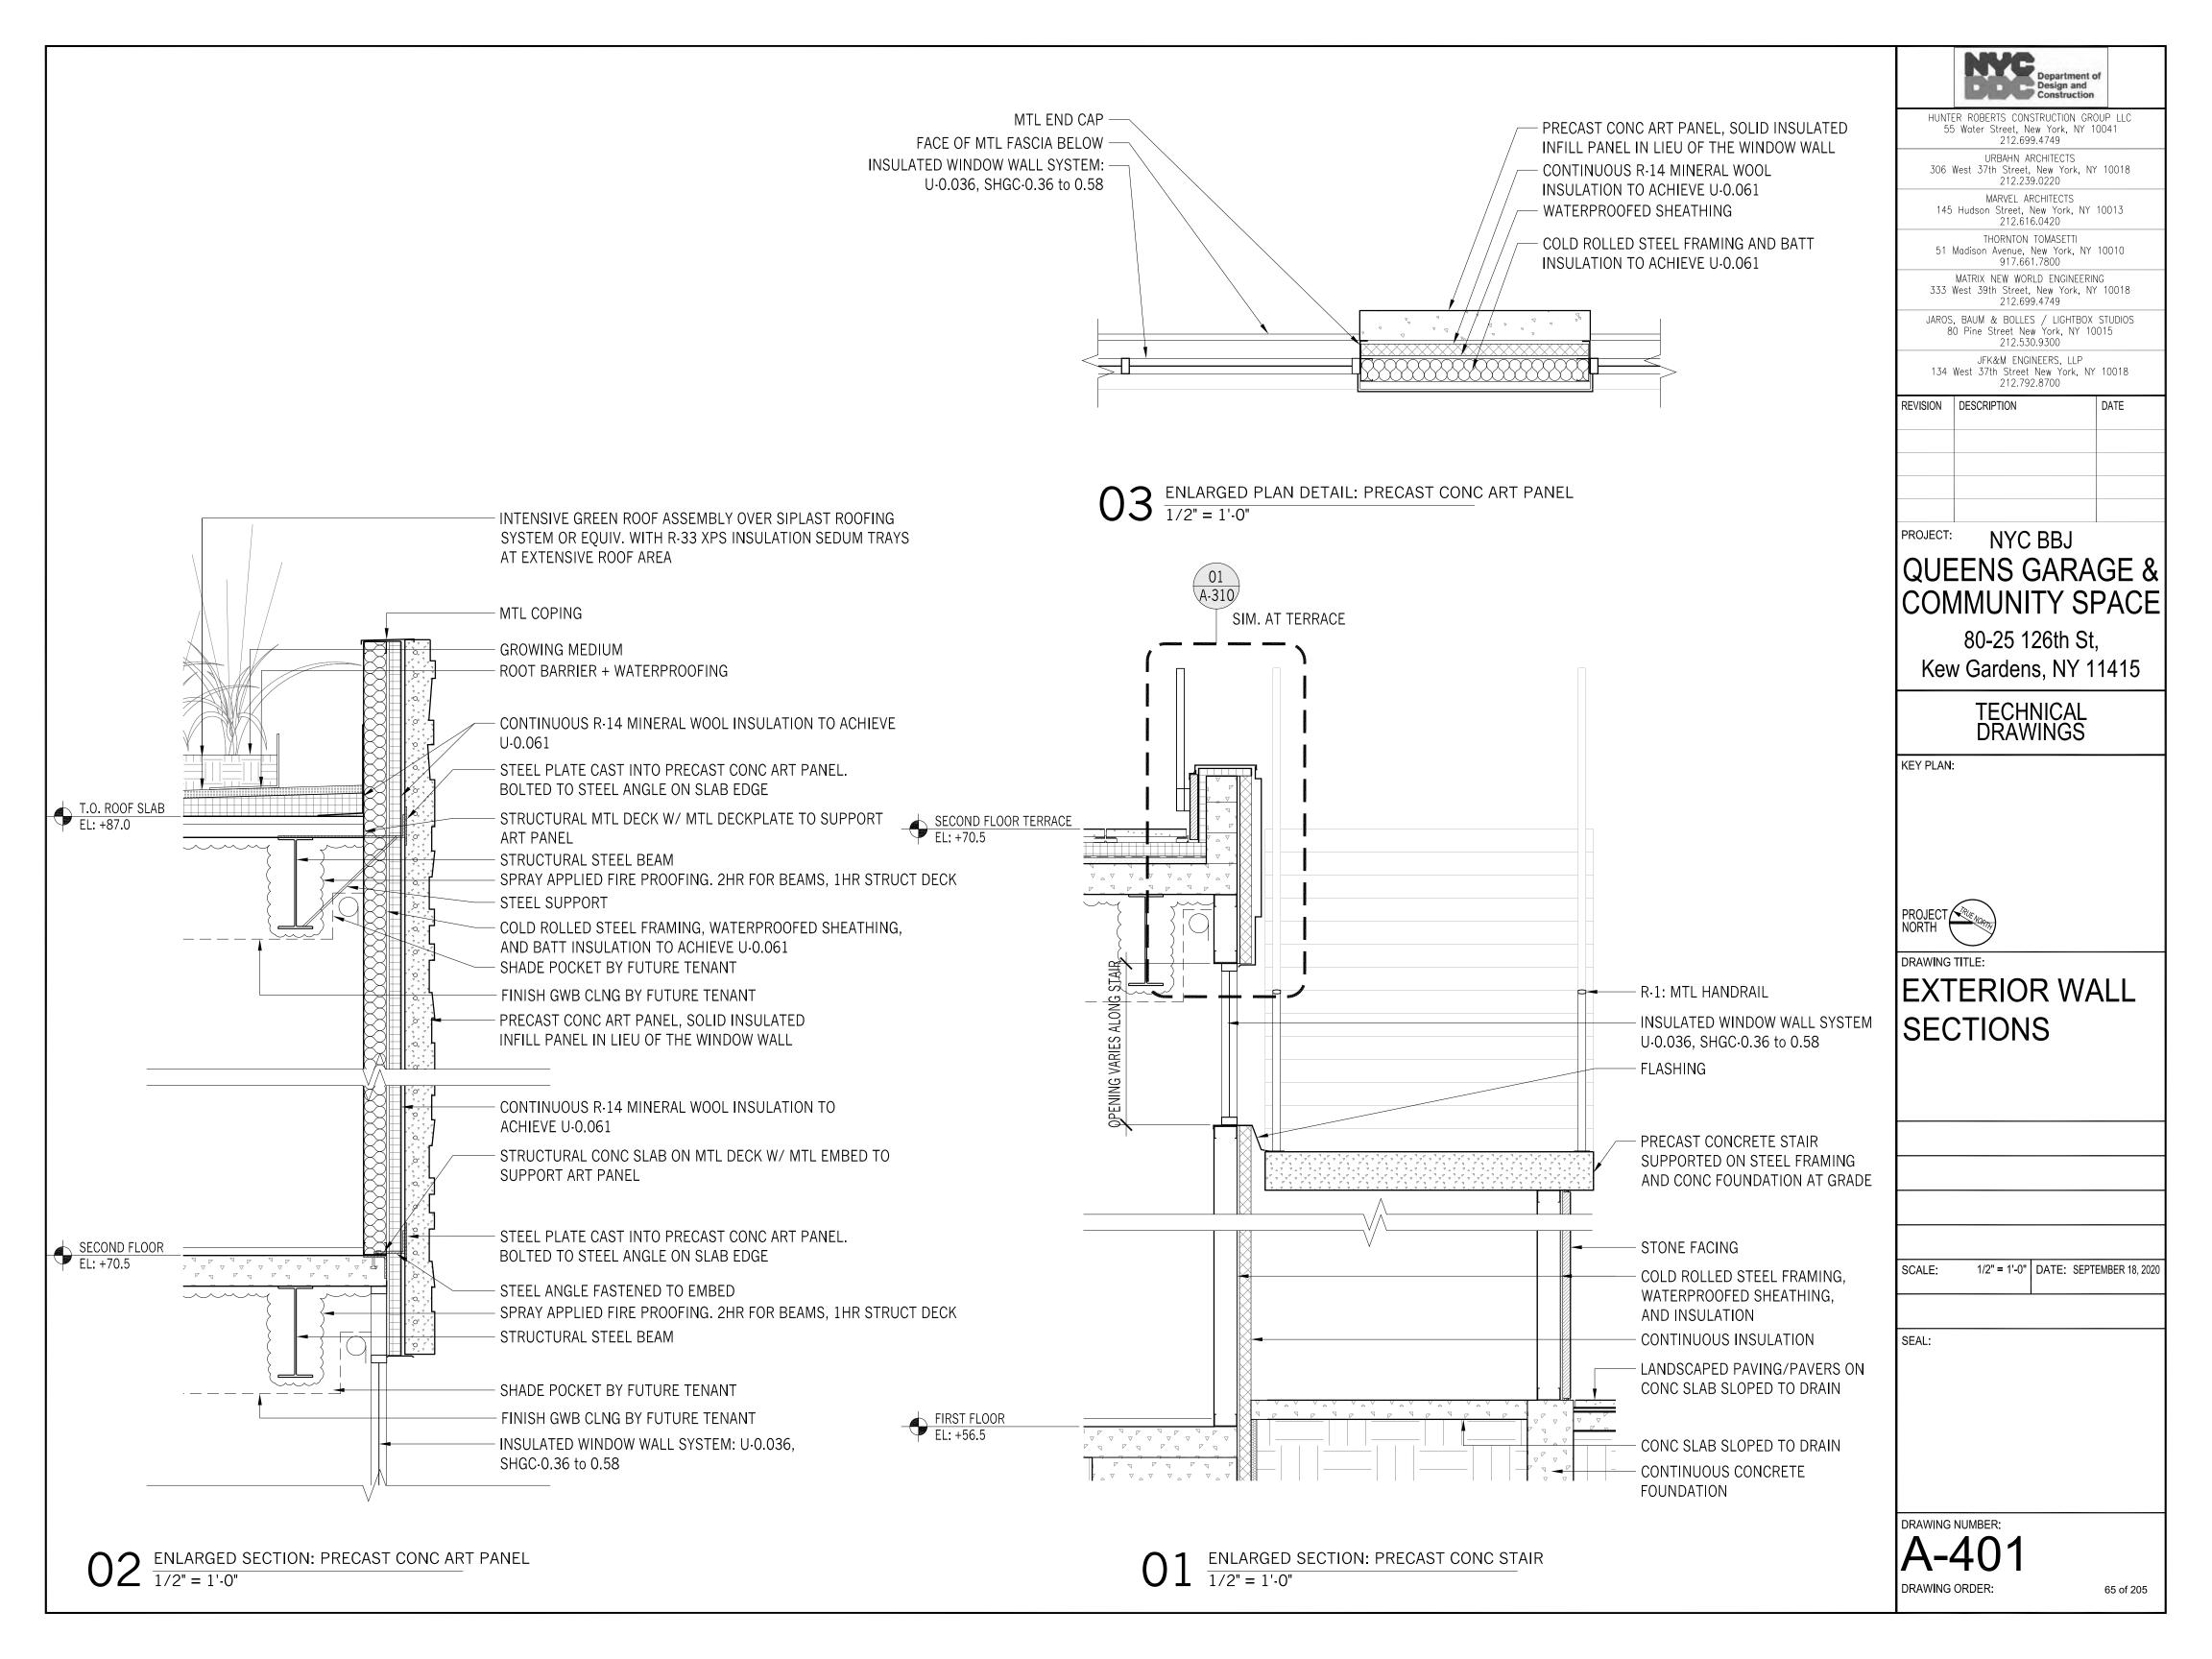

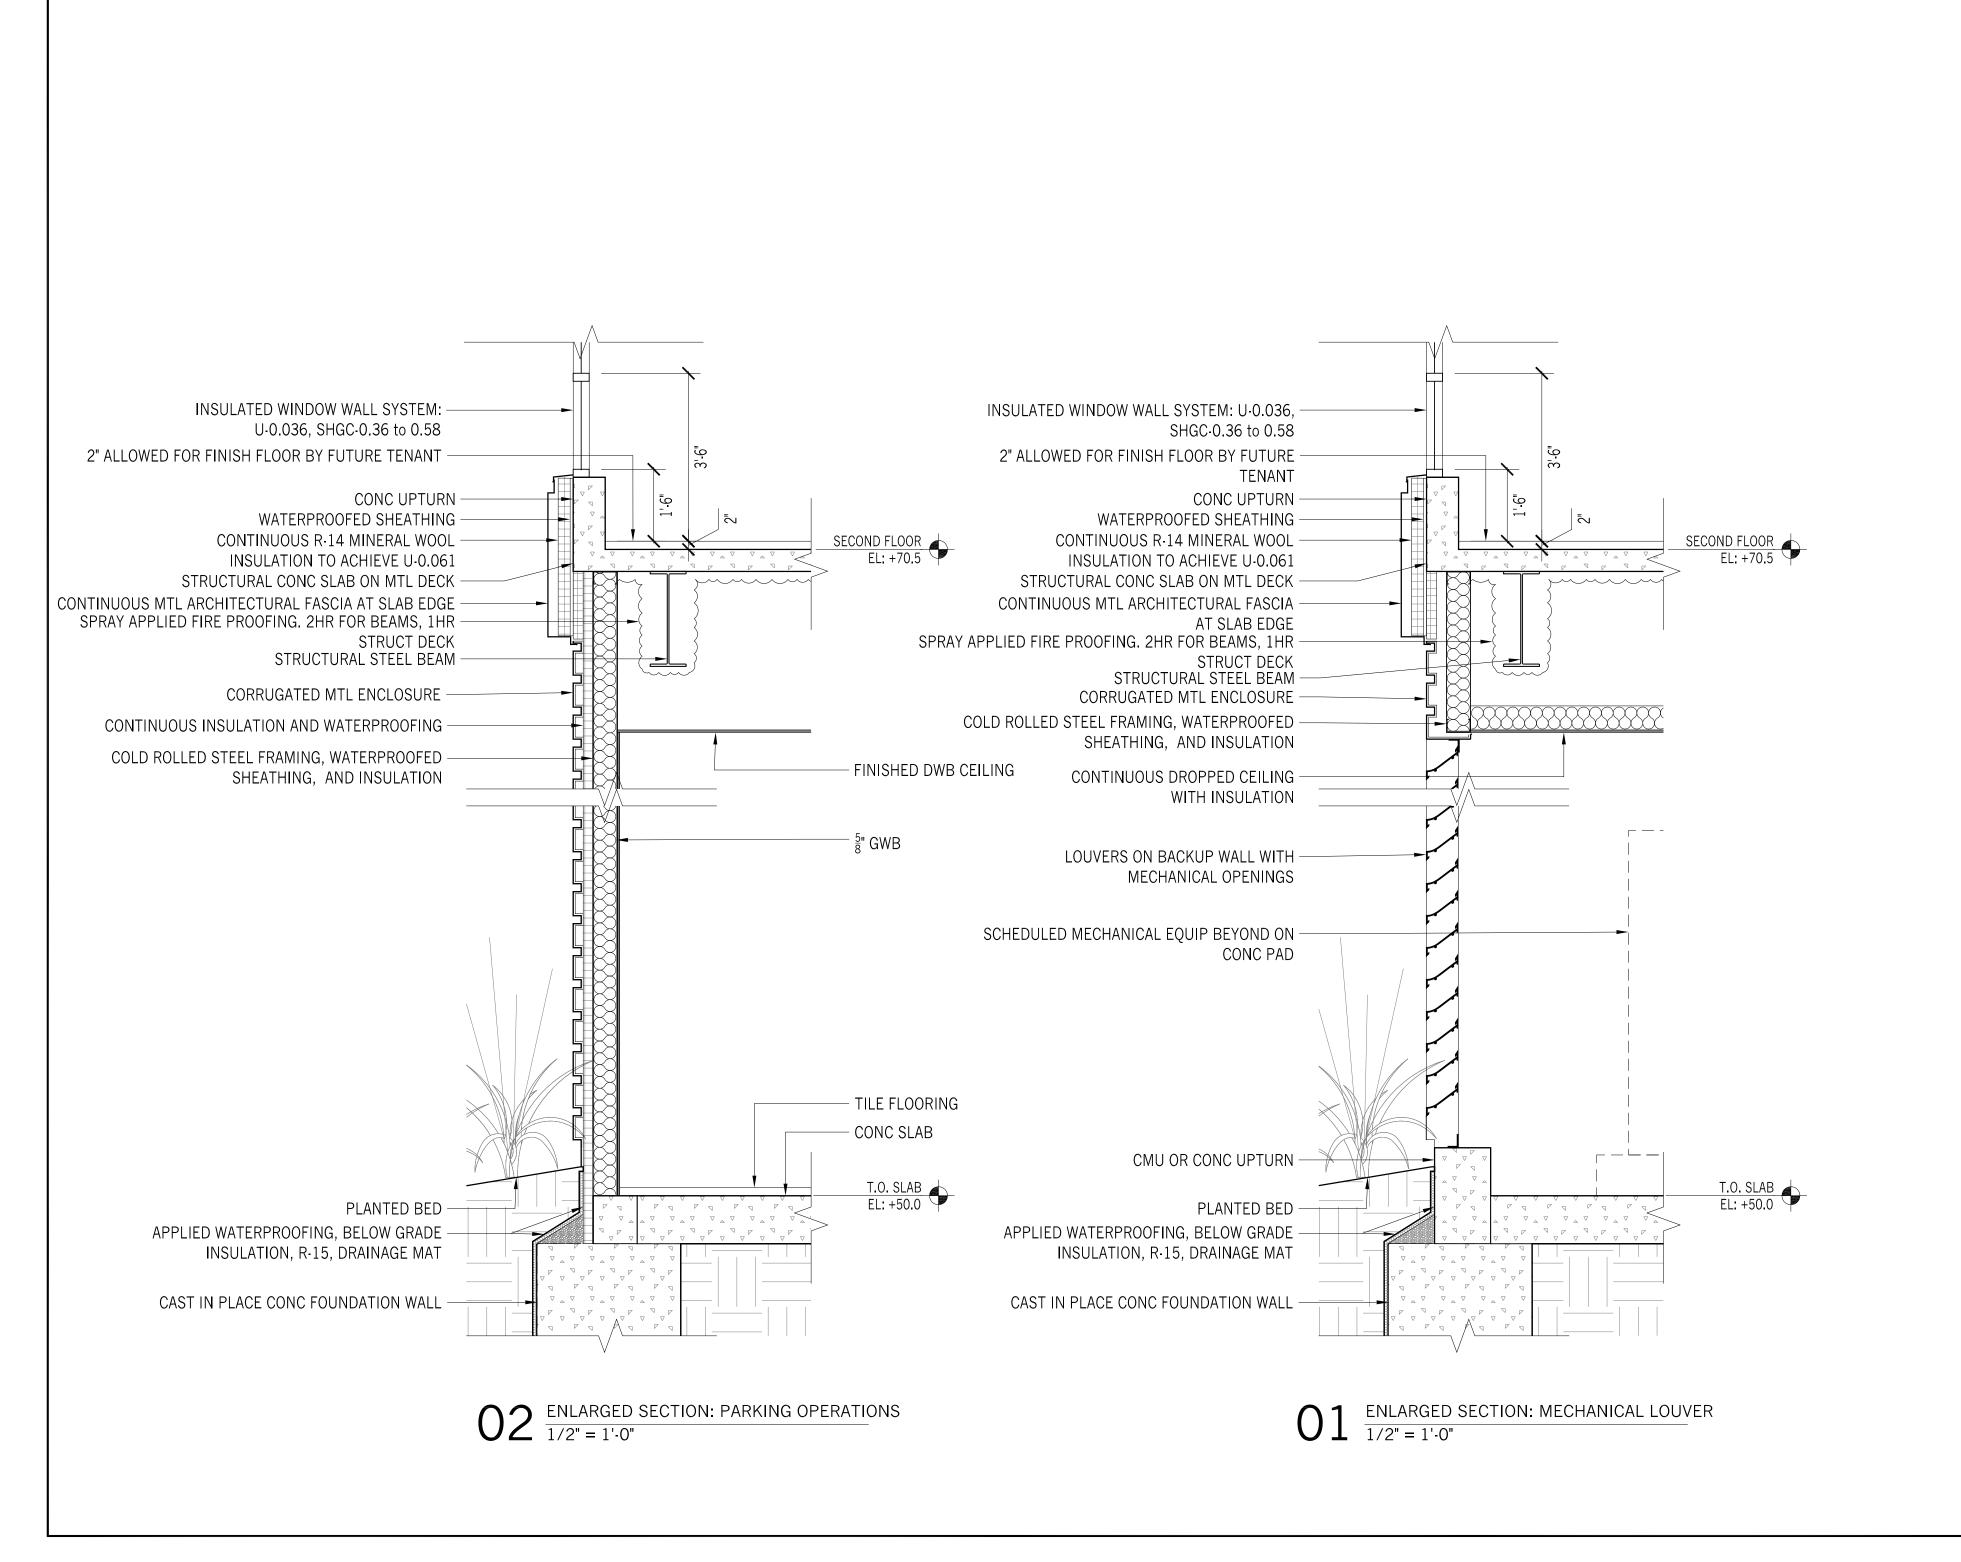



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REVISION	DESCRIPTION	DATE

PROJECT: NYC BBJ

QUEENS GARAGE & COMMUNITY SPACE

80-25 126th St, Kew Gardens, NY 11415

TECHNICAL DRAWINGS

PROJECT Proposition NORTH

DRAWING TITLE:

KEY PLAN:


EXTERIOR WALL SECTIONS


SCALE: 1/2" = 1'-0" DATE: SEPTEMBER 18, 2020

SEAL:


A-402

DRAWING ORDER:

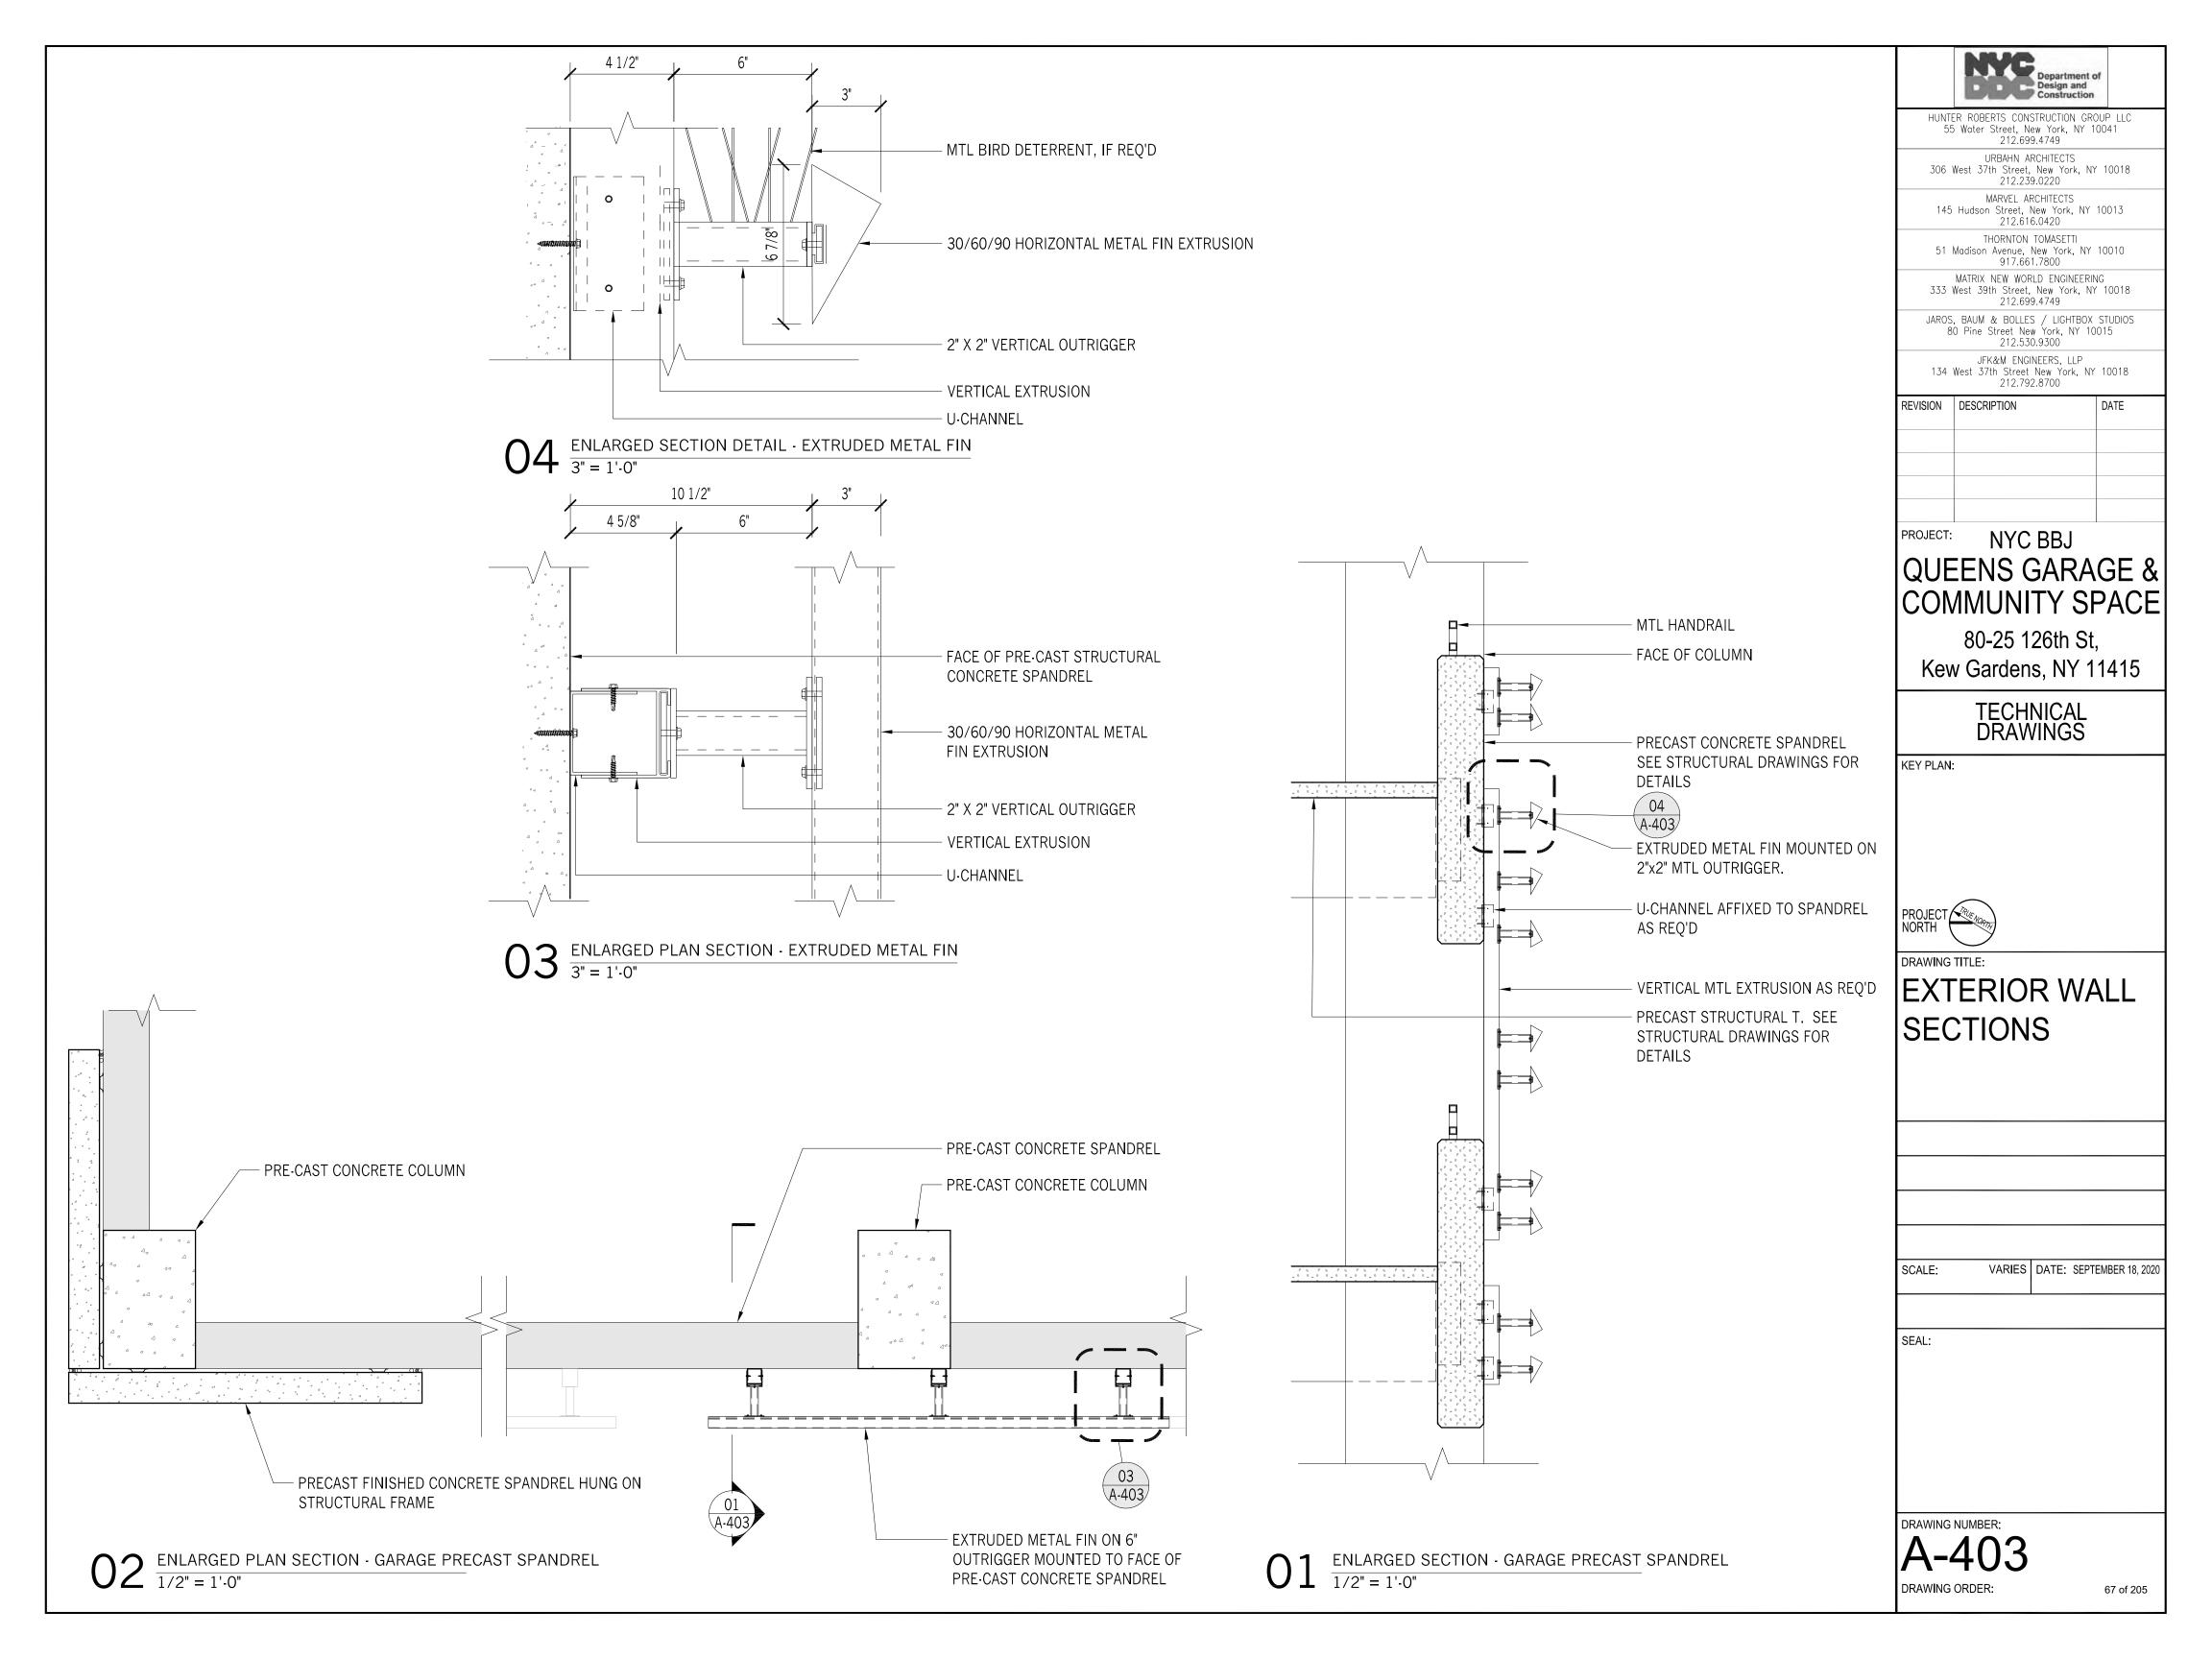

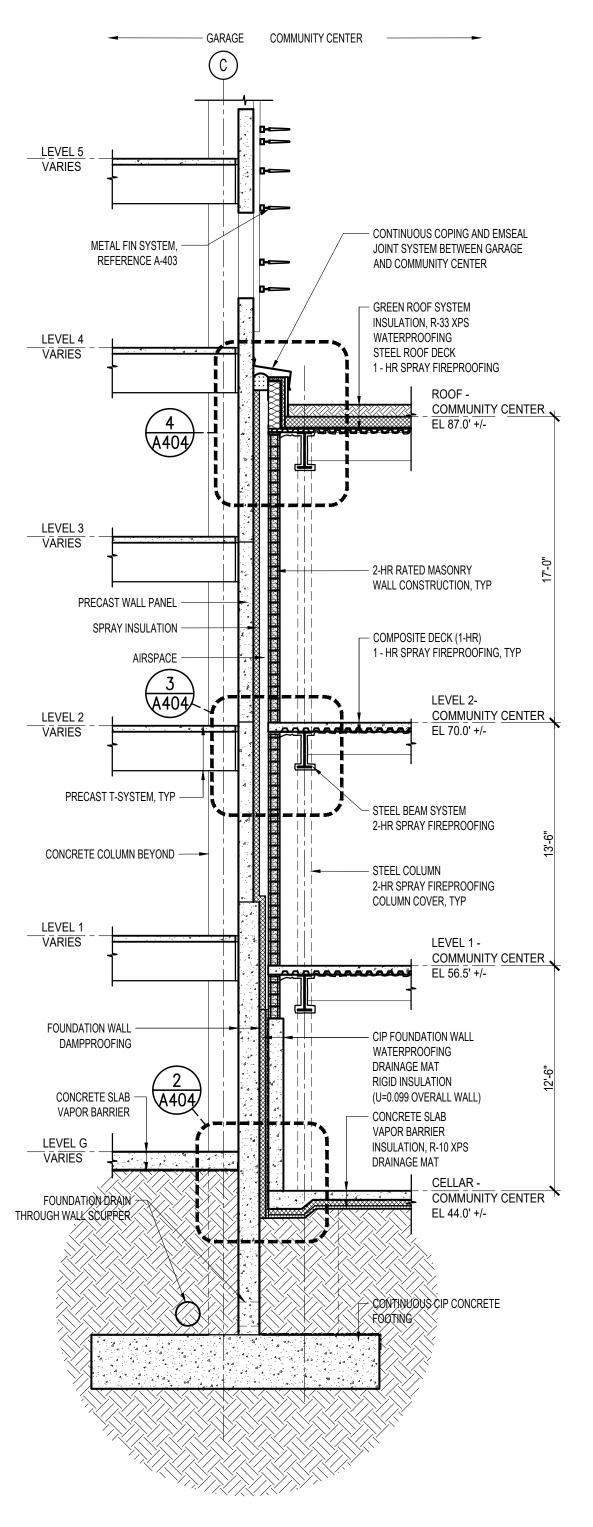

 $\frac{\text{WALL SECTION SHARED WALL ALONG GRID}}{3/16" = 1'-0"}$

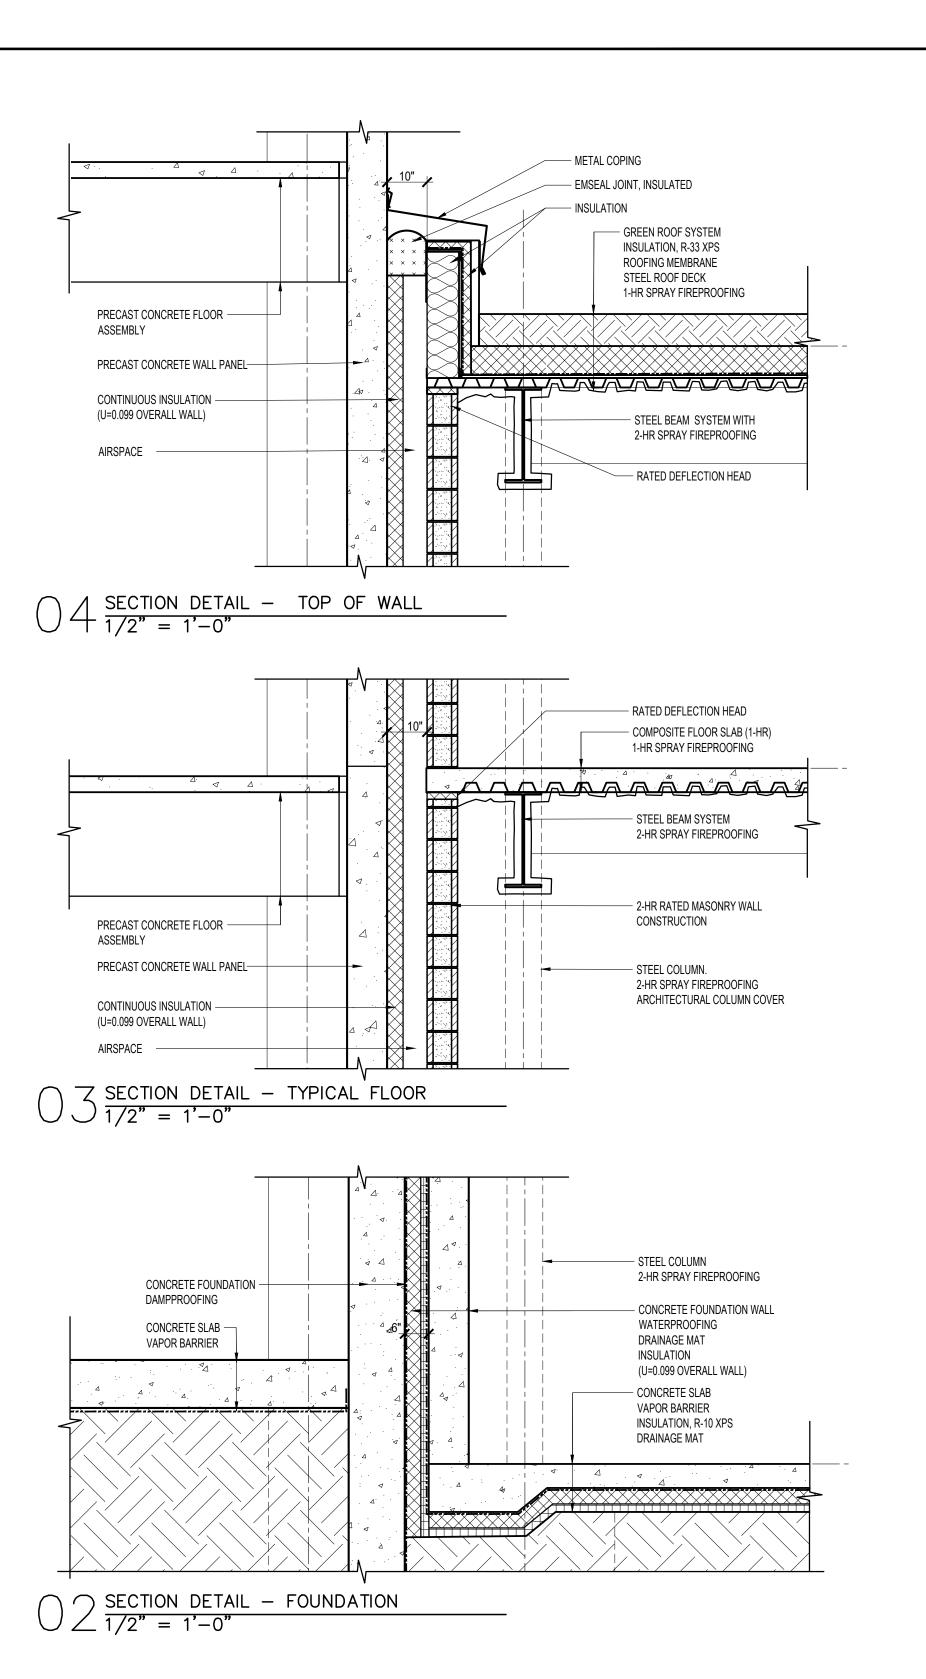

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JAROS, BAUM & BOLLES / LIGHTBOX STUDIOS 80 Pine Street New York, NY 10015 212.530.9300 JFK&M ENGINEERS, LLP 134 West 37th Street New York, NY 10018 212.792.8700 REVISION DESCRIPTION DATE PROJECT:

NYC BBJ QUEENS GARAGE & COMMUNITY SPACE

80-25 126th St, Kew Gardens, NY 11415

TECHNICAL DRAWINGS

DRAWING TITLE:

KEY PLAN:

WALL SECTION AND DETAILS


VARIES DATE: SEPTEMBER 18, 2020 SCALE:


SEAL:


DRAWING NUMBER:

68 of 205

DRAWING ORDER:

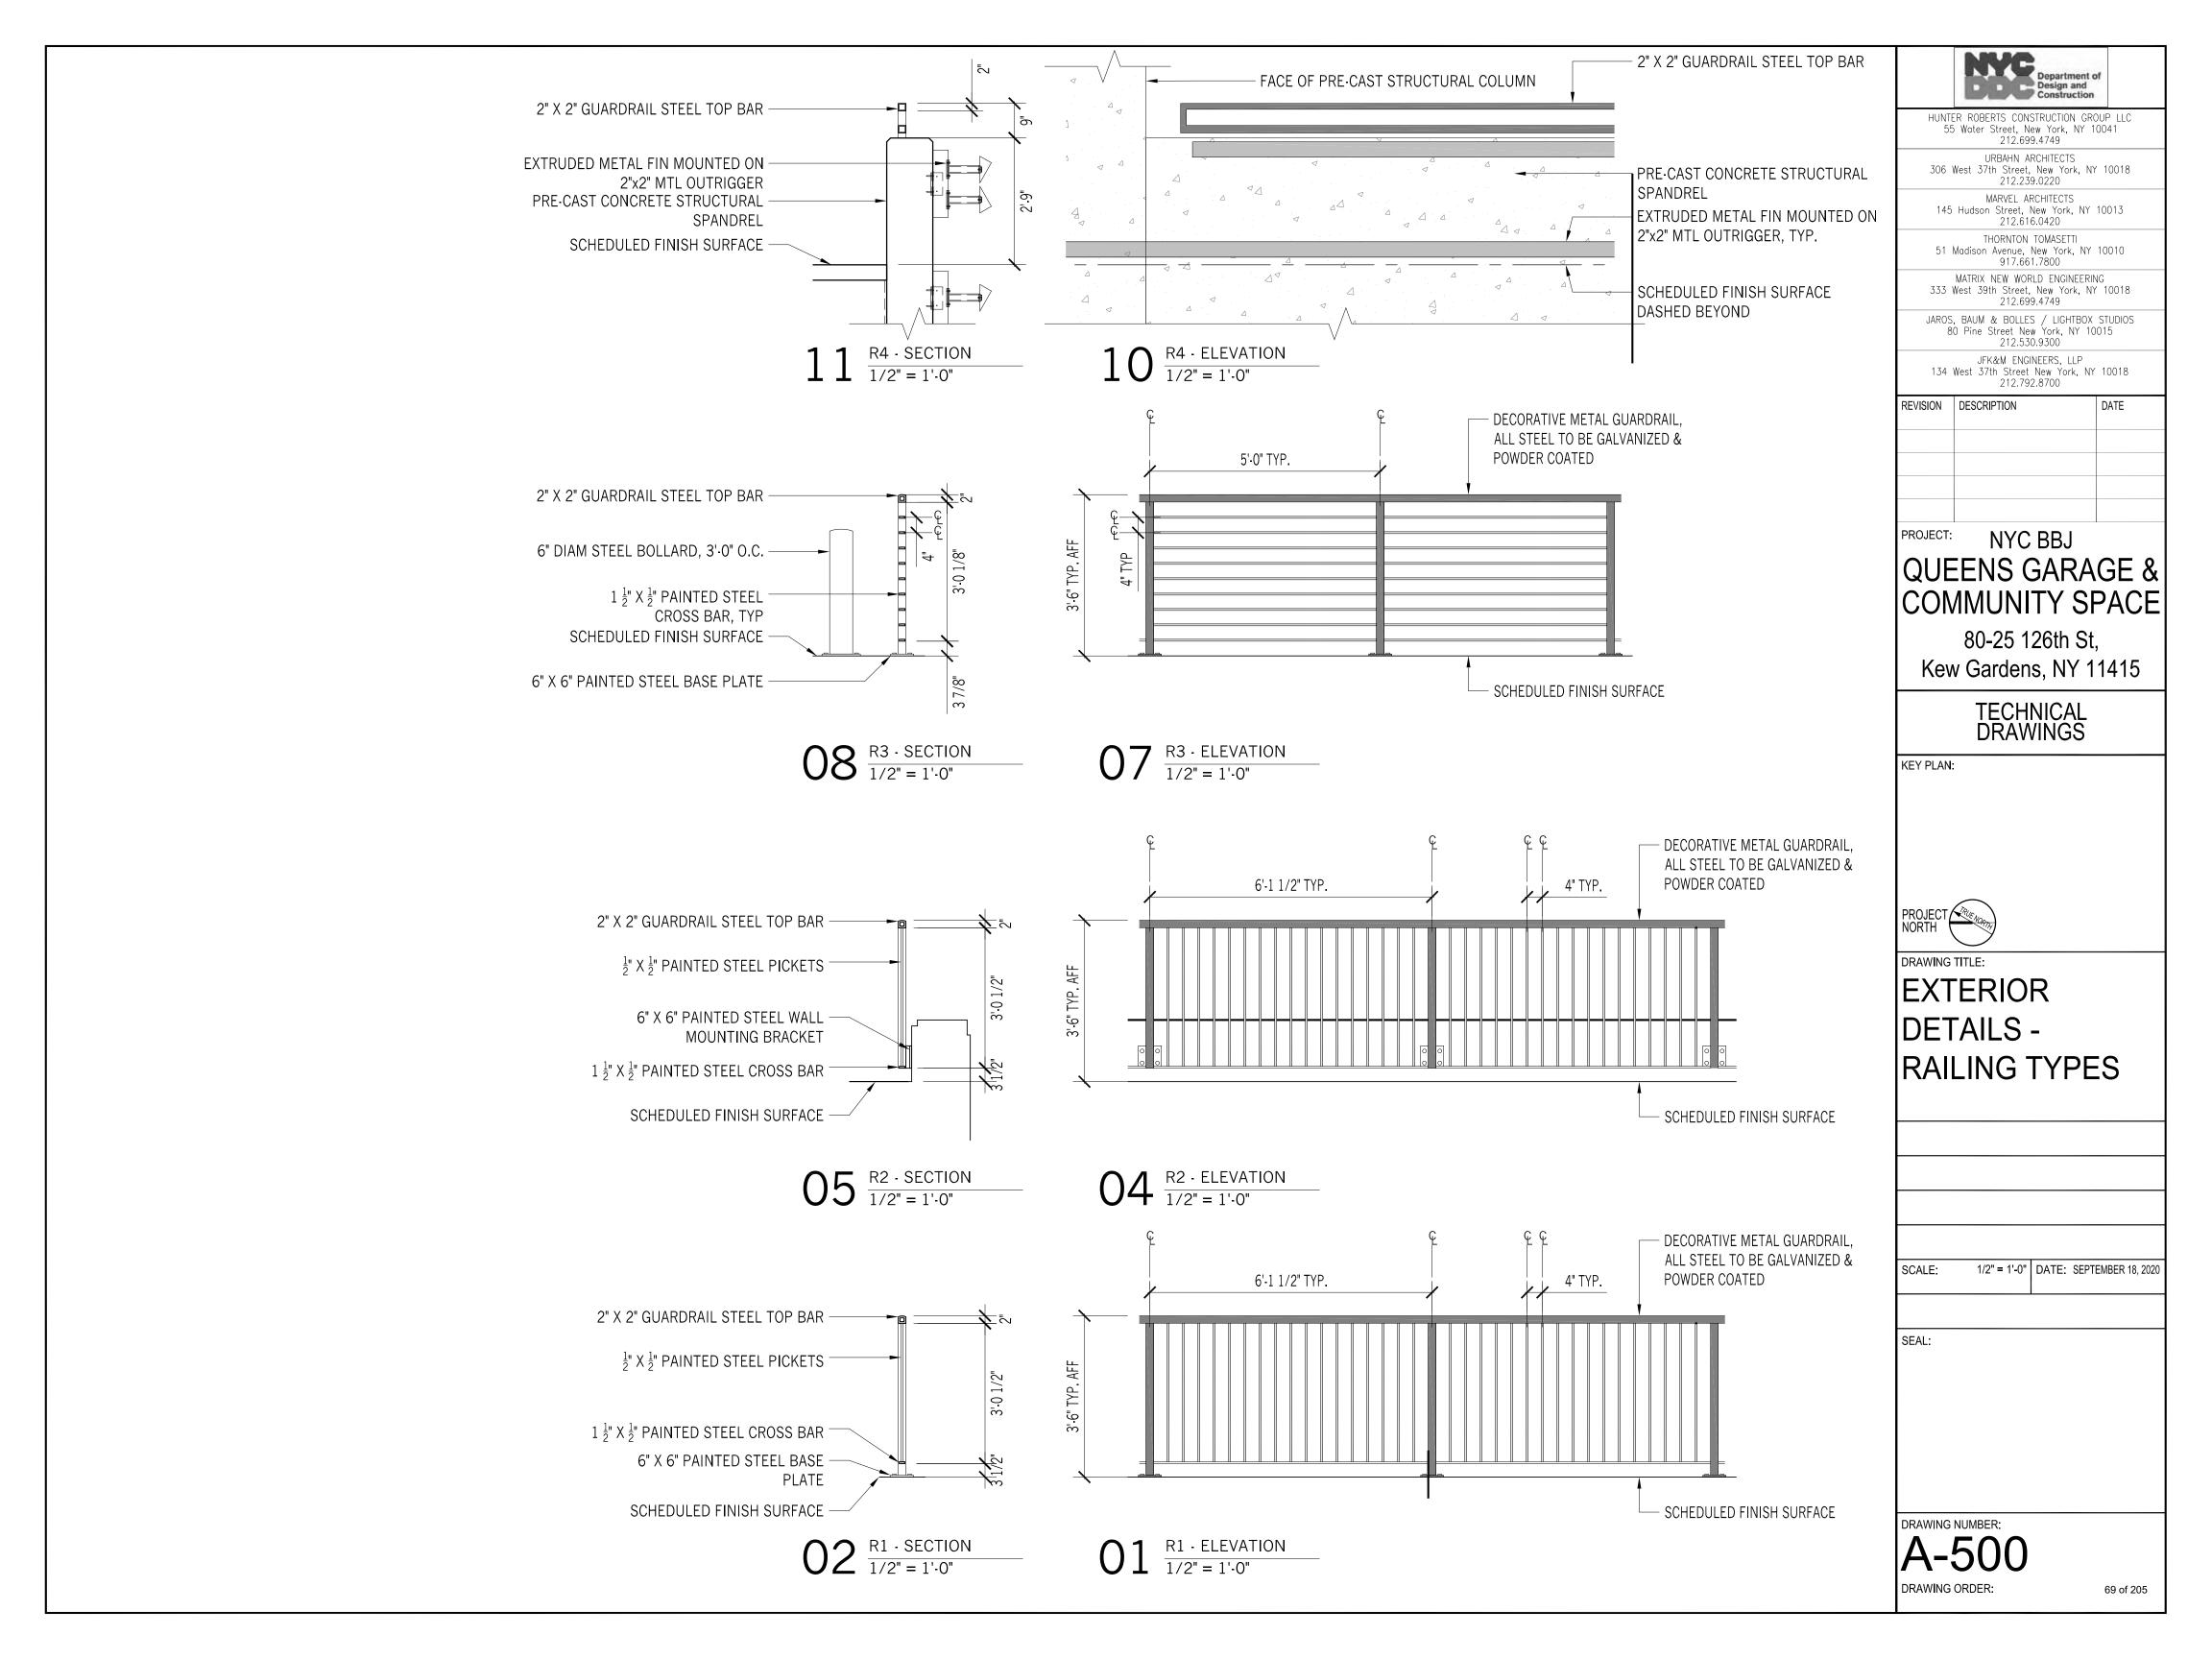

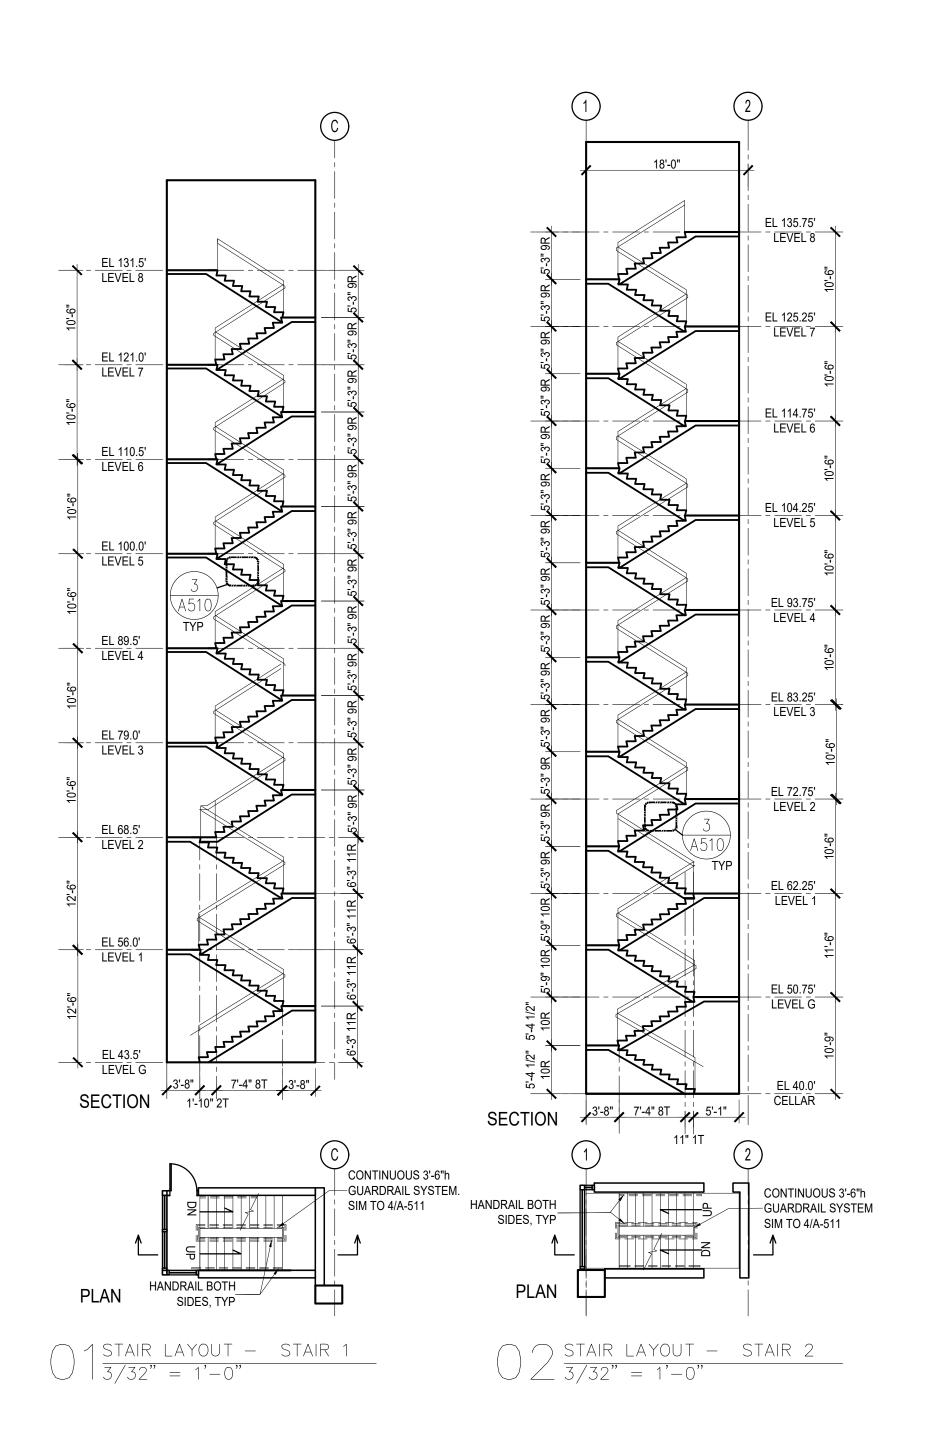

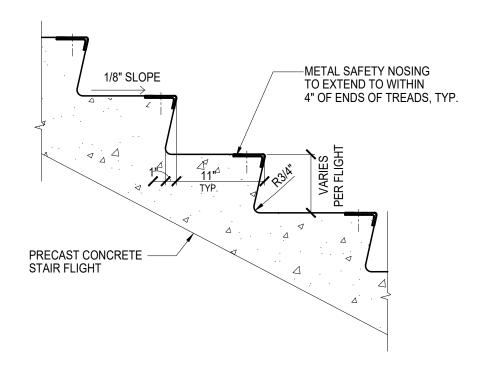

 $\int \frac{\text{STAIR DETAIL} - \text{PRECAST CONCRETE STAIR (STAIRS 1&2)}}{1" = 1'-0"}$

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REVISION DESCRIPTION DATE

PROJECT: NYC BBJ

QUEENS GARAGE & COMMUNITY SPACE

80-25 126th St, Kew Gardens, NY 11415

TECHNICAL DRAWINGS

KEY PLAN:

DRAWING TITLE:


STAIR DETAILS -STAIR 1 AND 2

SCALE: VARIES DATE: SEPTEMBER 18, 2020

SEAL:

DRAWING NUMBER:
A-510

DRAWING ORDER:

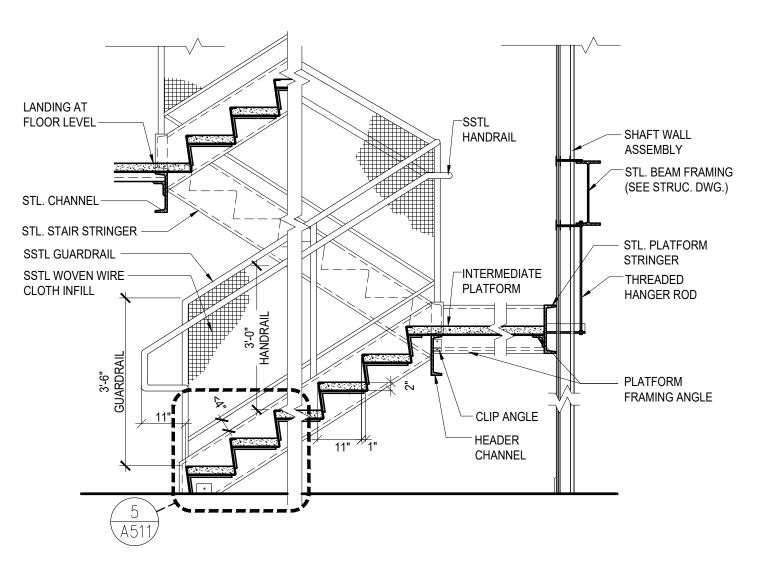

STAIR DETAIL - GUARDRAIL, LANDING, AND TYPICAL FLIGHT STEEL STAIR - CONCRETE AND METAL PAN (STAIRS 3, 4, 5) $\frac{1}{2} = 1 - 0$

CONTINUOUS 3'-6"h

GUARDRAIL SYSTEM

EL 87.0' ROOF


EL 70.5'

LEVEL 2

EL 50.0'

LEVEL 1 (LOWER) 3'-8" 10'-1" 11T

SECTION: REF 4/A-511 FOR METAL STAIR DETAILS

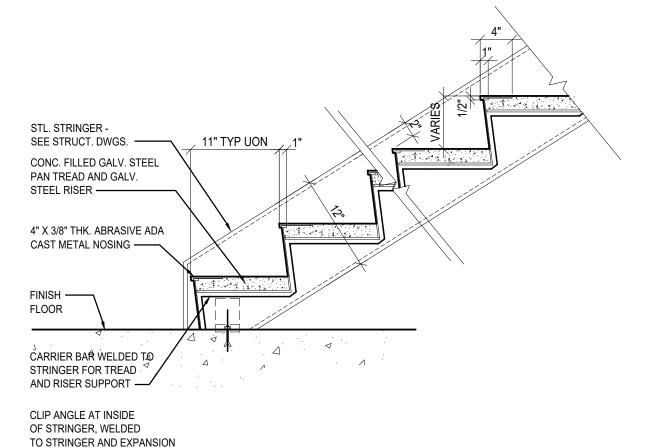


STAIR DETAIL - TYPICAL TREAD AND RISER STEEL STAIR - CONCRETE AND METAL PAN


(g)

 $\int \frac{(STAIRS 3, 4, 5)}{1" = 1'-0"}$

BOLTED TO CONC. SLAB

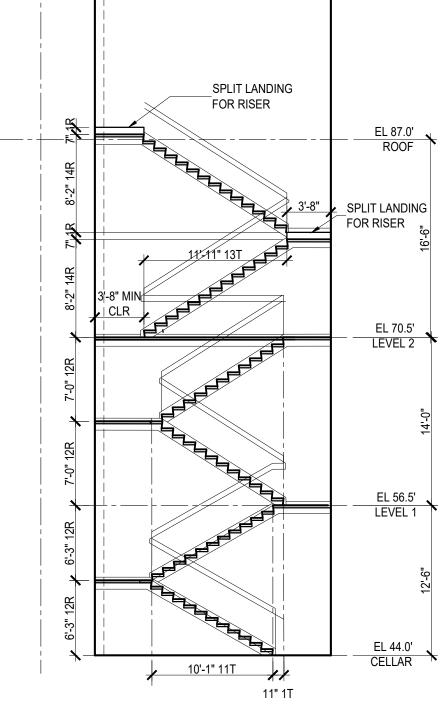

g

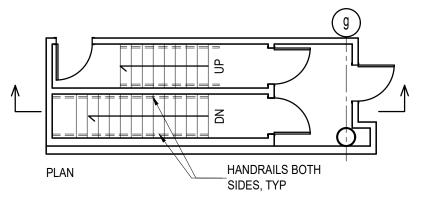

10'-1" 11T

 $\int \frac{\text{STAIR LAYOUT - STAIR 4}}{1/8" = 1'-0"}$


SECTION: REF 4/A-511 FOR METAL STAIR DETAILS

EL 70.5'

LEVEL 2

EL 56.5' LEVEL 1

CELLAR

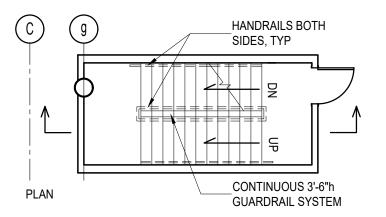

DRAWING NUMBER: DRAWING ORDER:

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NYC BBJ

QUEENS GARAGE &

COMMUNITY SPACE

80-25 126th St,

Kew Gardens, NY 11415

TECHNICAL DRAWINGS

STAIR DETAILS -

STAIRS 3, 4 AND 5

VARIES DATE: SEPTEMBER 18, 202

REVISION DESCRIPTION

KEY PLAN:


DRAWING TITLE:

SCALE:


SEAL:

71 of 205

HANDRAILS BOTH

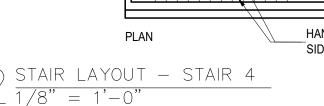

SECTION: REF 4/A-511 FOR METAL STAIR DETAILS

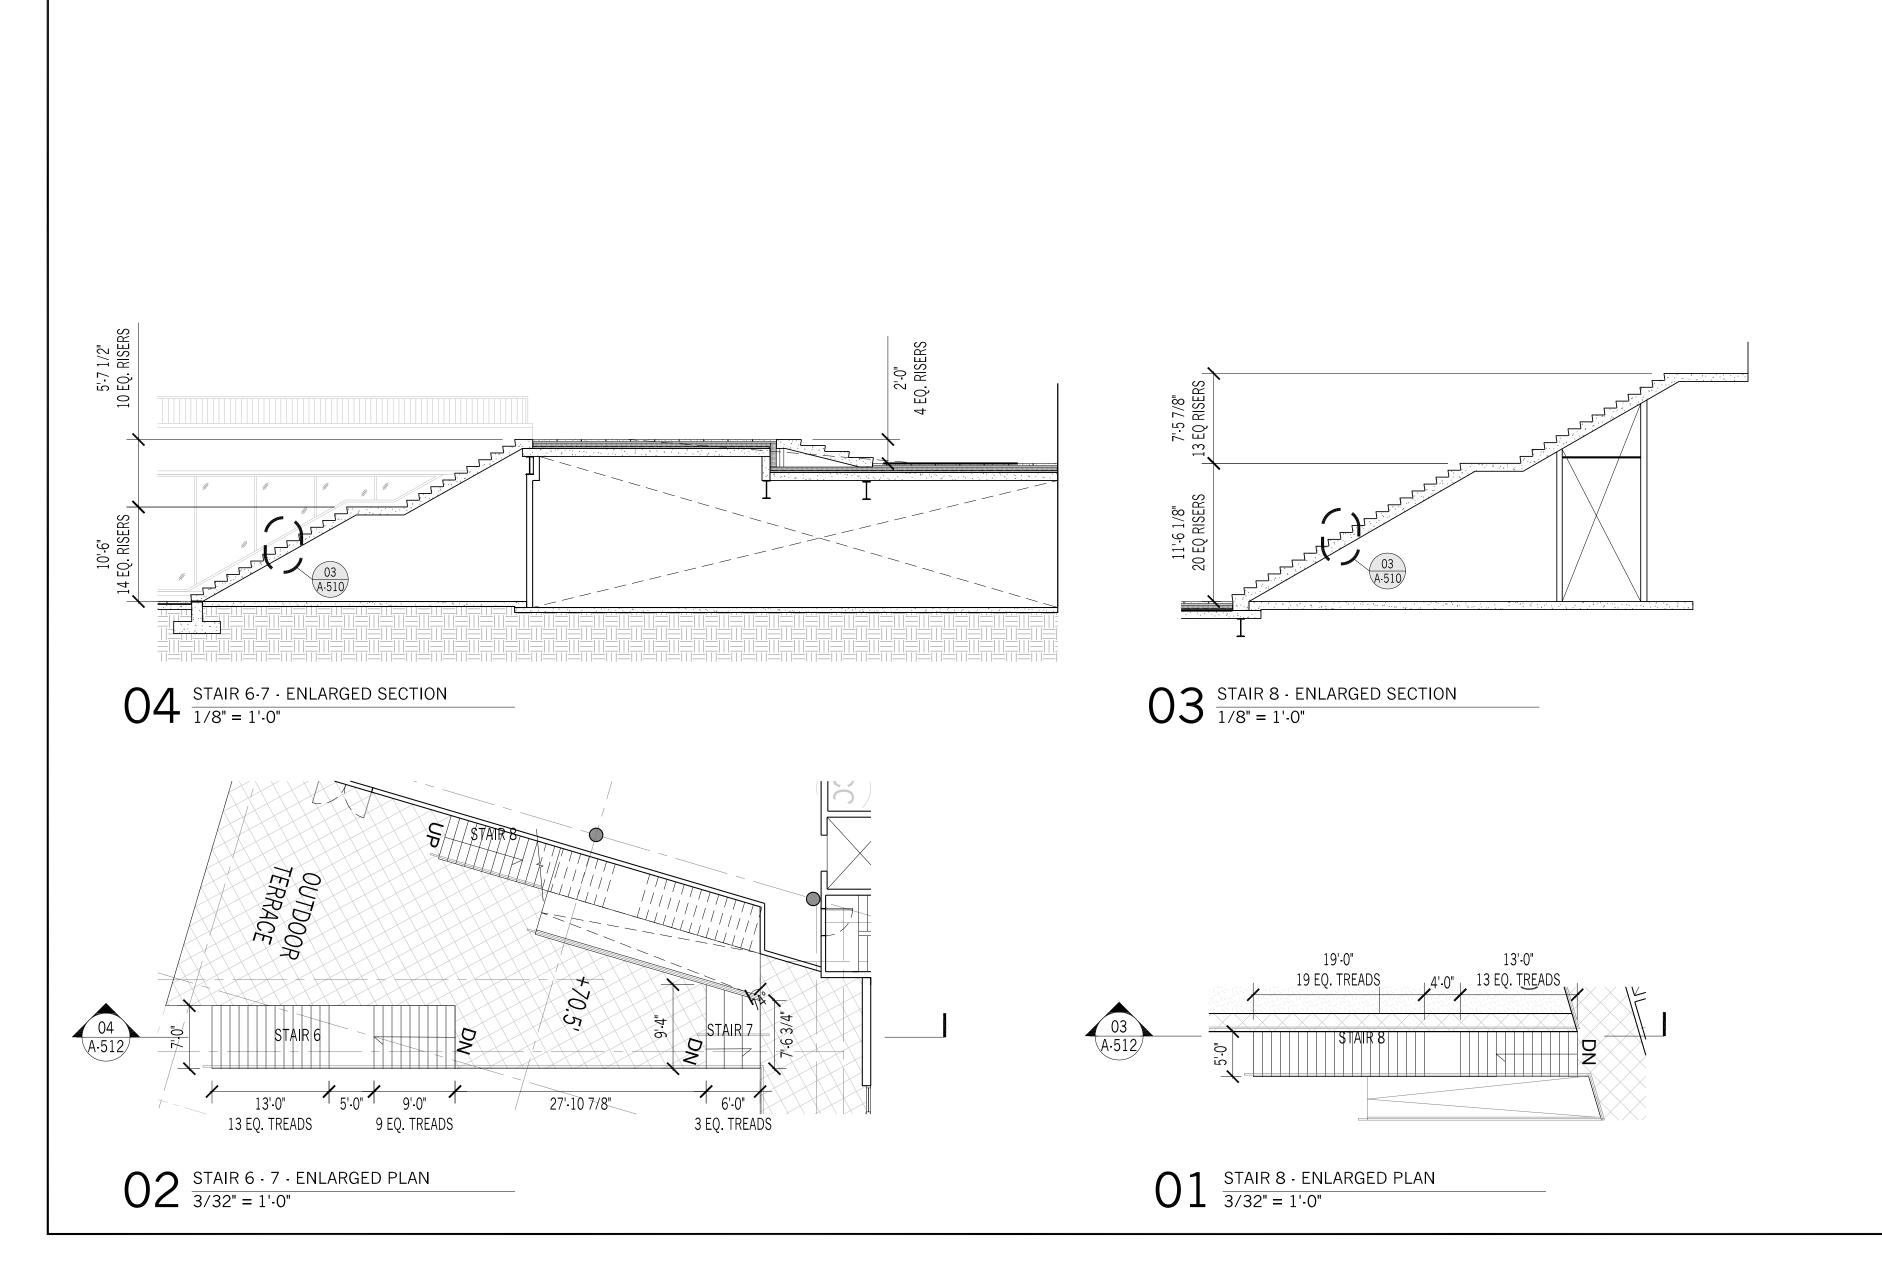



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REVISION	DESCRIPTION	DATE

NYC BBJ

QUEENS GARAGE & COMMUNITY SPACE

80-25 126th St, Kew Gardens, NY 11415

TECHNICAL DRAWINGS

DDO IECT A	`
PROJECT (***NORTH	77

KEY PLAN:

DRAWING TITLE:

STAIR DETAILS -STAIRS 6, 7 + 8

SCALE:	VARIES	DATE:	SEPTEMBER 18, 2
OO/ILL.	V/ (((L C	D/ (12.	OLI ILINIDLI

DRAWING NUMBER:
A-512

DRAWING ORDER:

	ELEVATOR 1	ELEVATOR 2	ELEVATOR 3
CRITERIA BASED ON ARCHITECTURAL DESIGN			
LOCATION	GARAGE	GARAGE	COMMUNITY CENTER
EXPOSURE	EXTERIOR	EXTERIOR	INTERIOR
NO. STOPS	9	9	3
VERTICAL RUN	87'-6"	87'-6"	26'-6"
SHAFT SIZE SHOWN	16' W X 10'-4" D CLEAR, SHARED WITH ELEVATOR 2	SEE ELEVATOR 1	8'-0" W X 7'-4" D CLEAR* MAY BE REVISED TO FIT OVERHEAD GEARLESS TRACTION ELEVATOR AND CAR LARGE ENOUGH TO FIT STRETCHER
AVAILABLE CLEAR OVER-RUN	T.B.D	T.B.D	29'-6"
CLEAR PIT DEPTH	T.B.D	T.B.D.	T.B.D.
EMR LOCATION	ALL (3) ELEVATORS SHALL 1 E	MR AT CELLAR, ADJACENT TO ELEV. 3 SH	AFT
ELEVATOR MACHINE ROOM SIZE	8'-5" W X 7'-8" D CLEAR	SHOWN (SHARED BY ALL 3 ELEVATORS)	


OWNER'S RFP REQUIRMENTS 45 SECONDS 45 SECONDS NOT PRESCRIBED MAXIMUM AVERAGE INTERVAL SEE DESIGN CRITERIA IN APPENDIX SEE DESIGN CRITERIA IN APPENDIX NOT PRESCRIBED HANDLING CAPACITY HOSPITAL CONFIG: MIN. 3,500 LBS RATED LOAD HOSPITAL CONFIG: MIN. 3,500 LBS HOSPITAL CONFIG: MIN. 3,500 LBS HOSPITAL CONFIG: MIN. 3,500 LBS STANDARD CONFIG.: MIN. 4,000 LBS HOSPITAL CONFIG: MIN. 3,500 LBS 350 FPM 150 FPM MINIMUM SPEED NOT PRESCRIBED FOR RUNS < 30' PREFERRED ELEVATOR TYPE OVERHEAD GEARLESS TRACTION OVERHEAD GEARLESS TRACTION CAR TO ACCOMODATE STRETCHER YES, REQUIRED YES, REQUIRED UNCLEAR IF REQUIRED. ARCHITECT PREFERS TO INCLUDE ROOM FOR STRETCHER PREFFERED AS A MATTER OF BEST PRACTICE AND UTILITY FOR THE COMMUNITY CENTER TENANT(S) SECURITY FEATURES KEY SWITCH FLOOR LOCKOUT KEY SWITCH FLOOR LOCKOUT FLOOR LOCK-OFFS CAR ENCLOSURE FRAMING STEEL WITH TAMPER PROOF EQUIP. STEEL WITH TAMPER PROOF EQUIP. STREEL WITH NON-REMOVAMBLE WALL PANELS CAR, FRONT WALLS STAINLESS STEEL WITH #4 FIN. STAINLESS STEEL WITH #4 FIN. STAINLESS STEEL WITH #4 FIN. CAR-SIDE WALLS STAINLESS STEEL WITH #4 FIN. STAINLESS STEEL WITH #4 FIN. **BRONZE WITH STAINLESS FRAMES** STAINLESS STEEL WITH #4 FIN. STAINLESS STEEL WITH #4 FIN. CAR- BACK WALLS **BRONZE WITH STAINLESS FRAMES** HAND RAILS STAINLESS STEEL STAINLESS STEEL STAINLESS STEEL CAR, FLOOR NON-SLIP EPOXY NON-SLIP EPOXY NON-SLIP EPOXY CAR CEILING S.S. WITH LED LIGHTING WITH LED LIGHTING WITH LED LIGHTING

SEE APPENDICES FOR ADDITIONAL VERTICAL TRANSPORT REQUIREMENTS, INCLUDING, BUT NOT LIMTED TO:

PER OWNER'S RFP, SPEED, CAPACITY AND PERFORMANCE BASED ON TRAFFIC FLOW IN GARAGE AND OCCUPANT LOAD. EXCEED MINIMUM SPEED AND CAPACITY LISTED ABOVE IF REQUIRED.

SUSTAINABILITY AND ENERGY CONSIDERATIONS

RELATED REQUIREMENTS FOR OTHER TRADES SUCH AS MECHANICAL, ELECTRICAL, TELECOM AND GENERAL CONSTRUCTION / ARCHITECTURAL DESIGN.

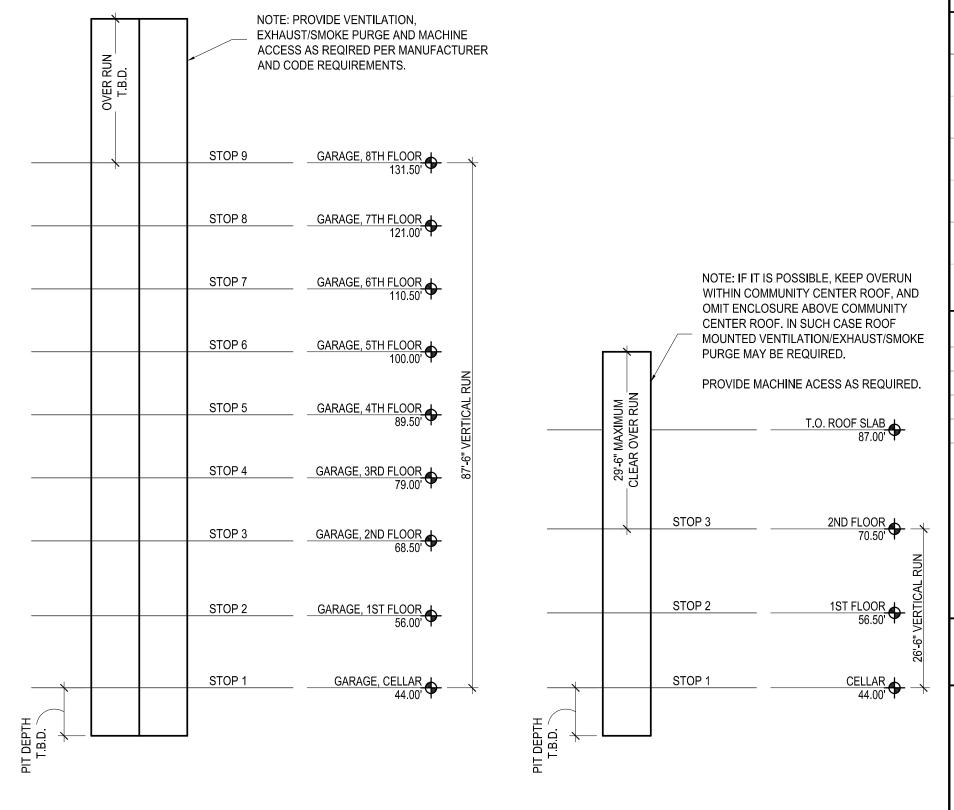


 $O = \frac{\text{ELEVATOR 3 SECTION DIAGRAM}}{1/16" = 1'-0"}$

PLANS NOTES:

CLEAR DIMENSIONS FOR BOTH SHAFTS ARE SHOWN BASED ON THE DESIGN ARCHITECT'S CURRENT PLAN.
PLEASE INFORM THE ARCHITECT IF ANY CHANGES TO THE SHAFT DIMENSIONS ARE REQUIRED IN ORDER TO MEET OWNERS PERFORMANCE CRITERIA,
CURRENT CODE AND/OR ELEVATOR MANUFACTURER'S REQUIREMENTS.

SHAFT PLAN DIAGRAMS HAVE BEEN ROTATED FOR THE PURPOSE OF THIS DRAWING.

DOOR CONFIGURATIONS FOR ALL ELEVATORS MAY VARY FROM WHAT IS SHOWN HERE.

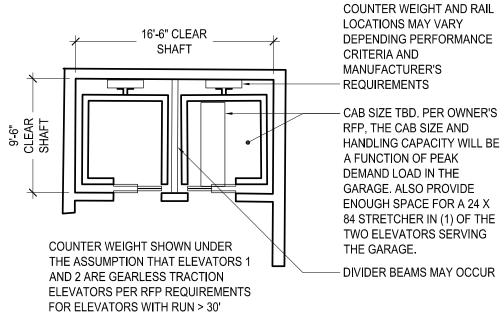

WILL BE

WILL BE


CETHE

UNDER THE ASSUMPTION THAT ELEVATOR 3 IS HYDRAULIC, COUNTERWEIGHT IS NOT SHOWN.

IF THE DESIGN BUILDER OPT TO INSTALL A
GEARLESS OVERHEAD TRACTION ELEVATOR
INSTEAD OF A HYDRAULIC SYSTEM FOR ELEVAOTR
3, THE SIZE OF THE SHAFT FOR ELEVATOR 3 MAY BE
REVISED/ENLARGED AS NECESSARY.

THE SHAFT MAY ALSO BE ENLARGED TO ACCOMMODATE A CAR THAT CAN FIT A STRETCHER.

 $\int \frac{\text{ELEVATOR 1 AND 2 SHAFT PLAN}}{1/8" = 1'-0"}$

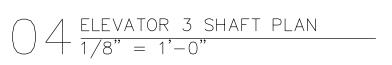

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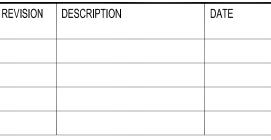
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QUEENS GARAGE & COMMUNITY SPACE

80-25 126th St, Kew Gardens, NY 11415

TECHNICAL DRAWINGS

KEY PLAN:



DRAWING TITLE:

ELEVATOR PLANS AND DETAILS

ALE:	VARIES	DATE:	SEPTEMBER 18, 2020


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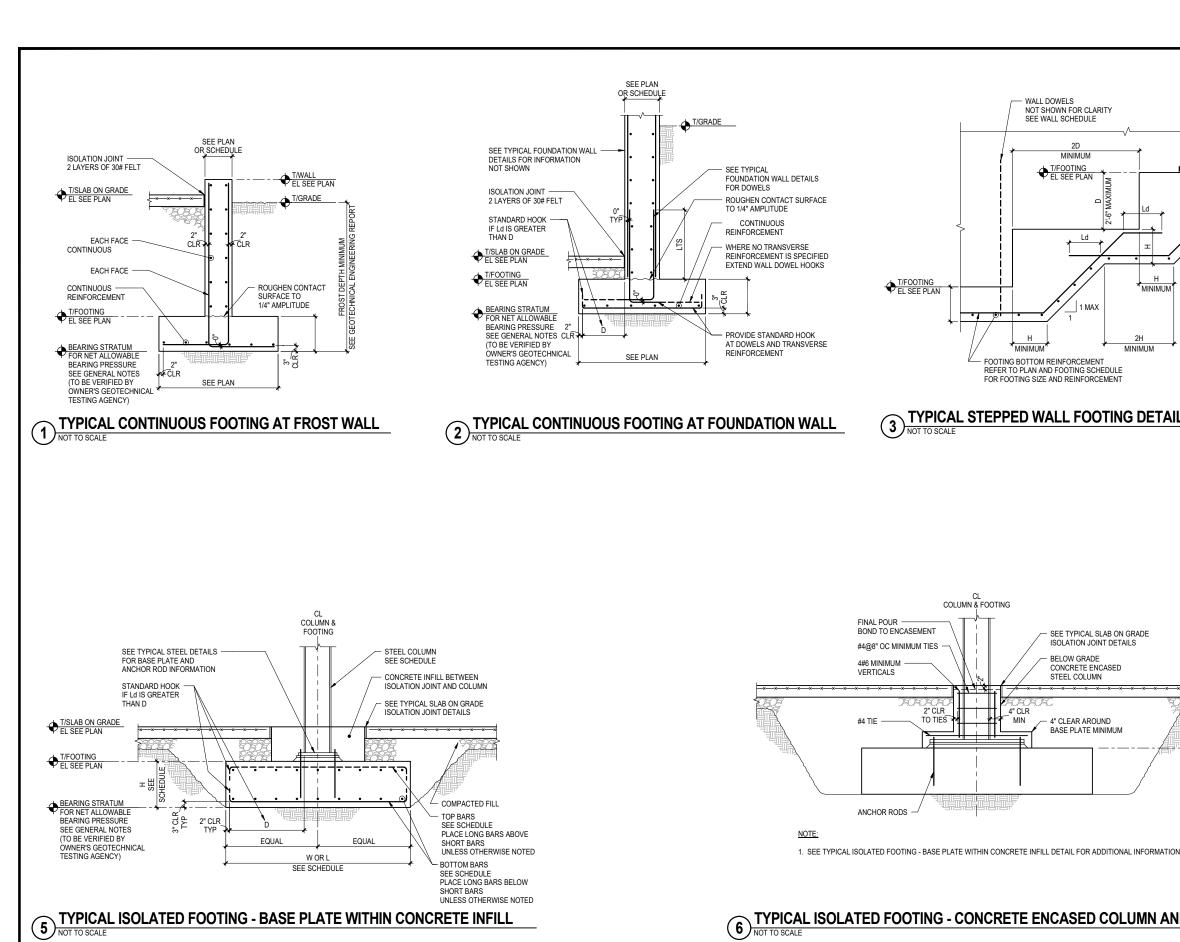
SEAL:

DRAWING NUMBER:

A-520

DRAWING ORDER:



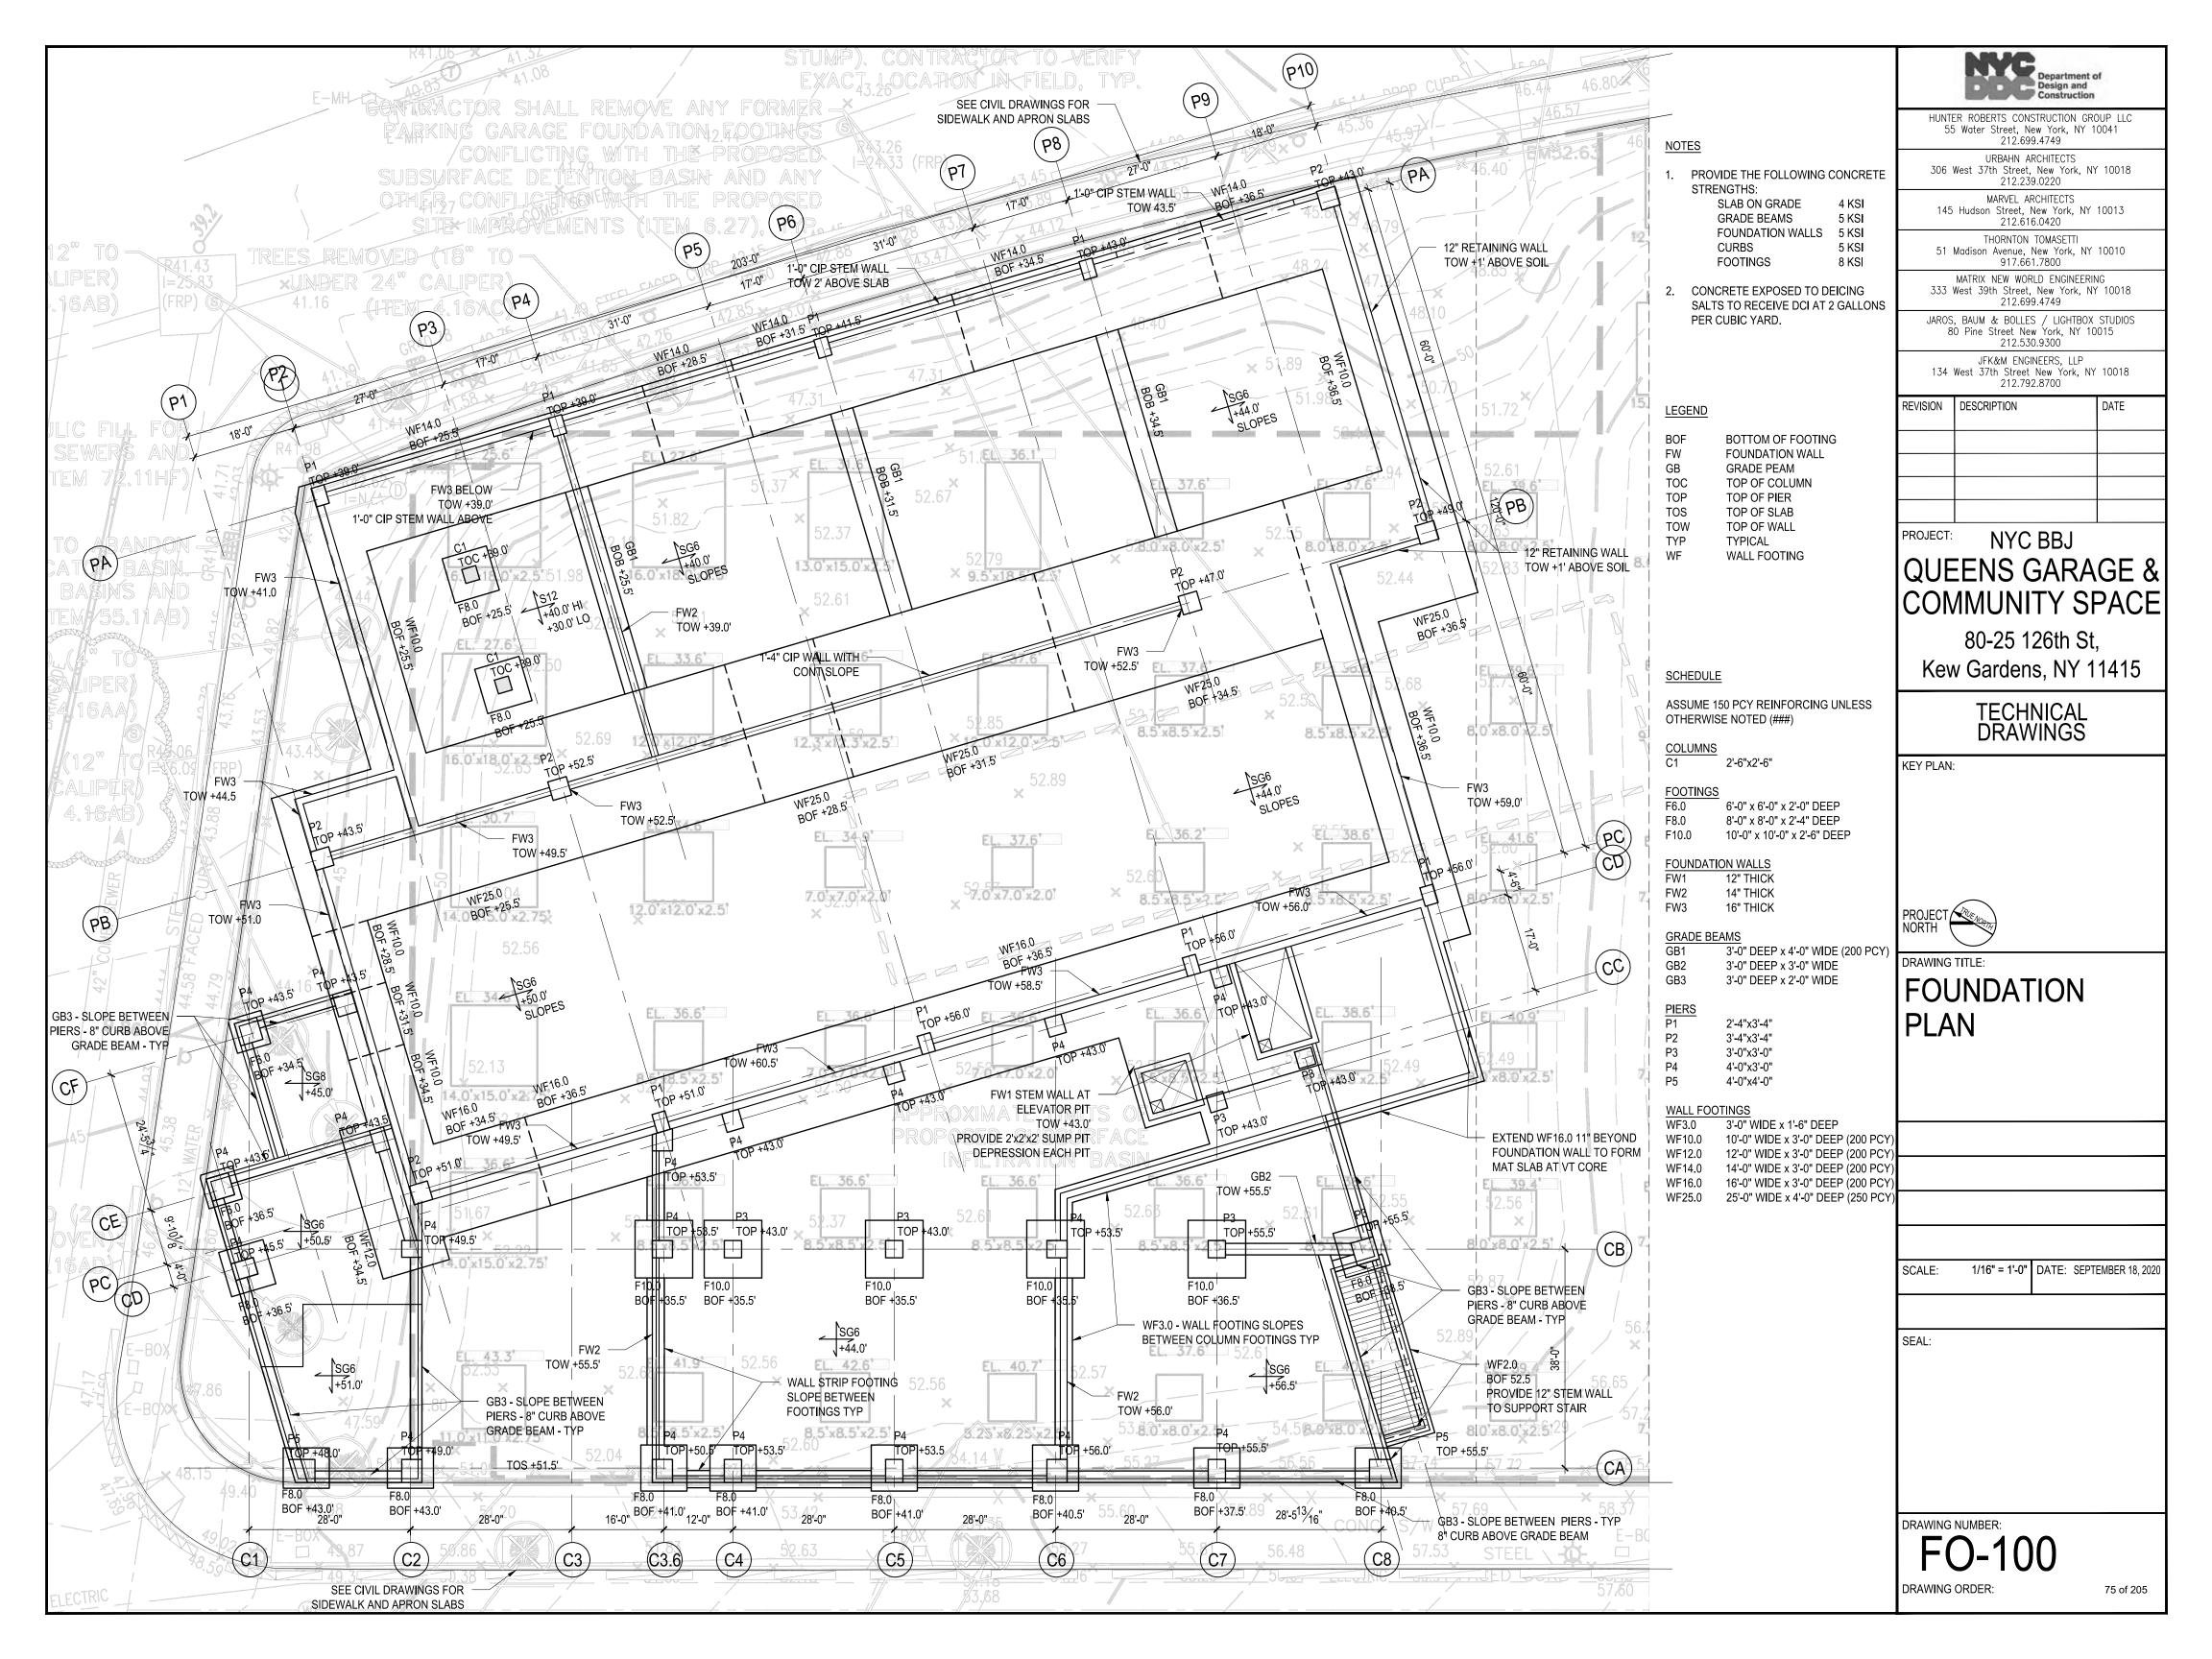

- STEEL COLUMN

- ANCHOR RODS

ANTICIPATED BEARING STRATUM
FOR NET ALLOWABLE BEARING
PRESSURE PER GEOTECHNICAL

ENGINEERING REPORT

ACTUAL BEARING STRATUM
REQUIRED TO ACHIEVE NET

- COMPACTED

EXTENT OF LEAN

CASE 2 ONLY

PIER SIZE AND REINFORCEMENT

CASE 2

CASE 1

1. THIS DETAIL SHALL NOT BE USED WITHOUT PRIOR WRITTEN APPROVAL FROM THE SER

2. THESE FOOTING INSTALLATION PROCEDURES ARE TO BE FOLLOWED IN THE EVENT THAT ANTICIPATED

AT CONTRACTOR'S OPTION, POUR LEAN CONCRETE (F'c=2000 PSI MINIMUM) TO THE ANTICIPATED BOTTOM OF FOOTING ELEVATION AND CAST FOOTING ON TOP OF LEAN CONCRETE

TYPICAL FOOTING DETAIL WHERE OVER-EXCAVATION IS REQUIRED

NET ALLOWABLE BEARING PRESSURE CANNOT BE OBTAINED AT THE ANTICIPATED STRATUM


PLACE FOOTING AT ACTUAL BEARING STRATUM. INSTALL PIER TO ANTICIPATED TOP OF

3. SEE TYPICAL ISOLATED FOOTING DETAILS FOR ADDITIONAL INFORMATION

8 DUE TO UNANTICIPATED SOIL CONDITIONS - STEEL COLUMN

STRUCTURAL ENGINEER

NOTES:

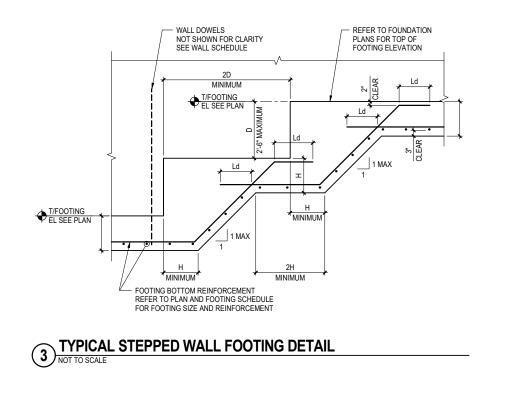

SEE TYPICAL SLAB ON GRADE


T/SLAB ON GRADE


T/FOOTING EL SEE PLAN

ISOLATION JOINT DETAILS

CONCRETE ENCASED STEEL COLUMN

BASE PLATE MINIMUM

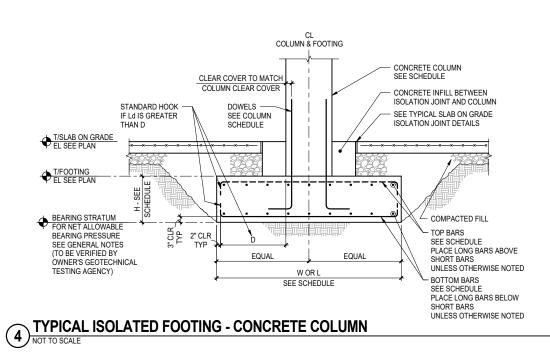

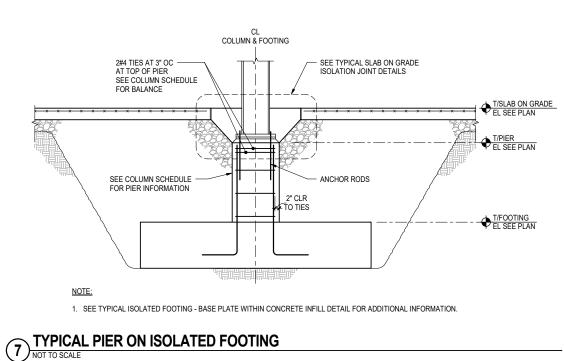


TYPICAL ISOLATED FOOTING - CONCRETE ENCASED COLUMN AND BASE PLATE
NOT TO SCALE


COLUMN & FOOTING


FINAL POUR BOND TO ENCASEMENT

VERTICALS

#4@8" OC MINIMUM TIES

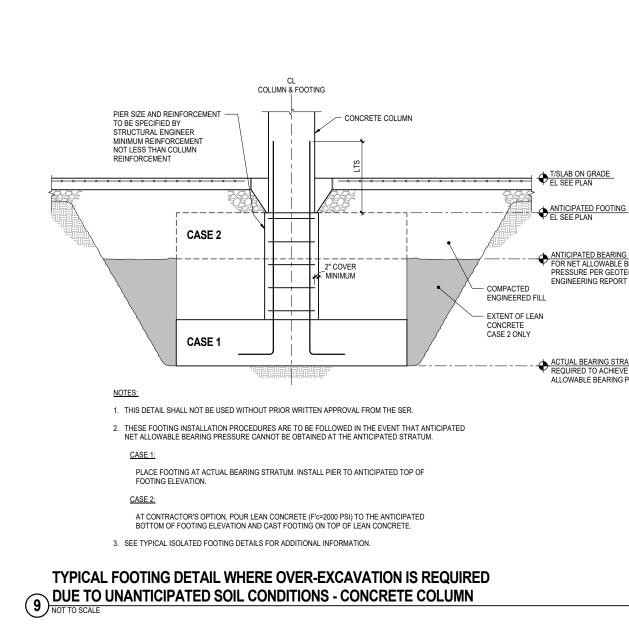

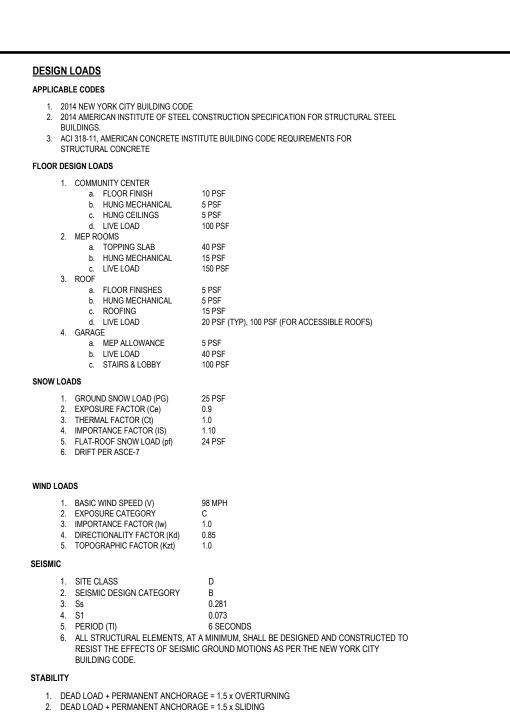

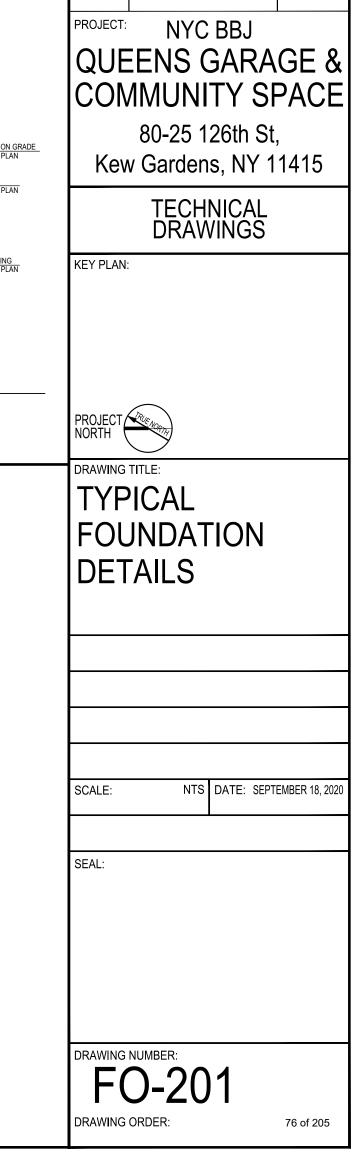

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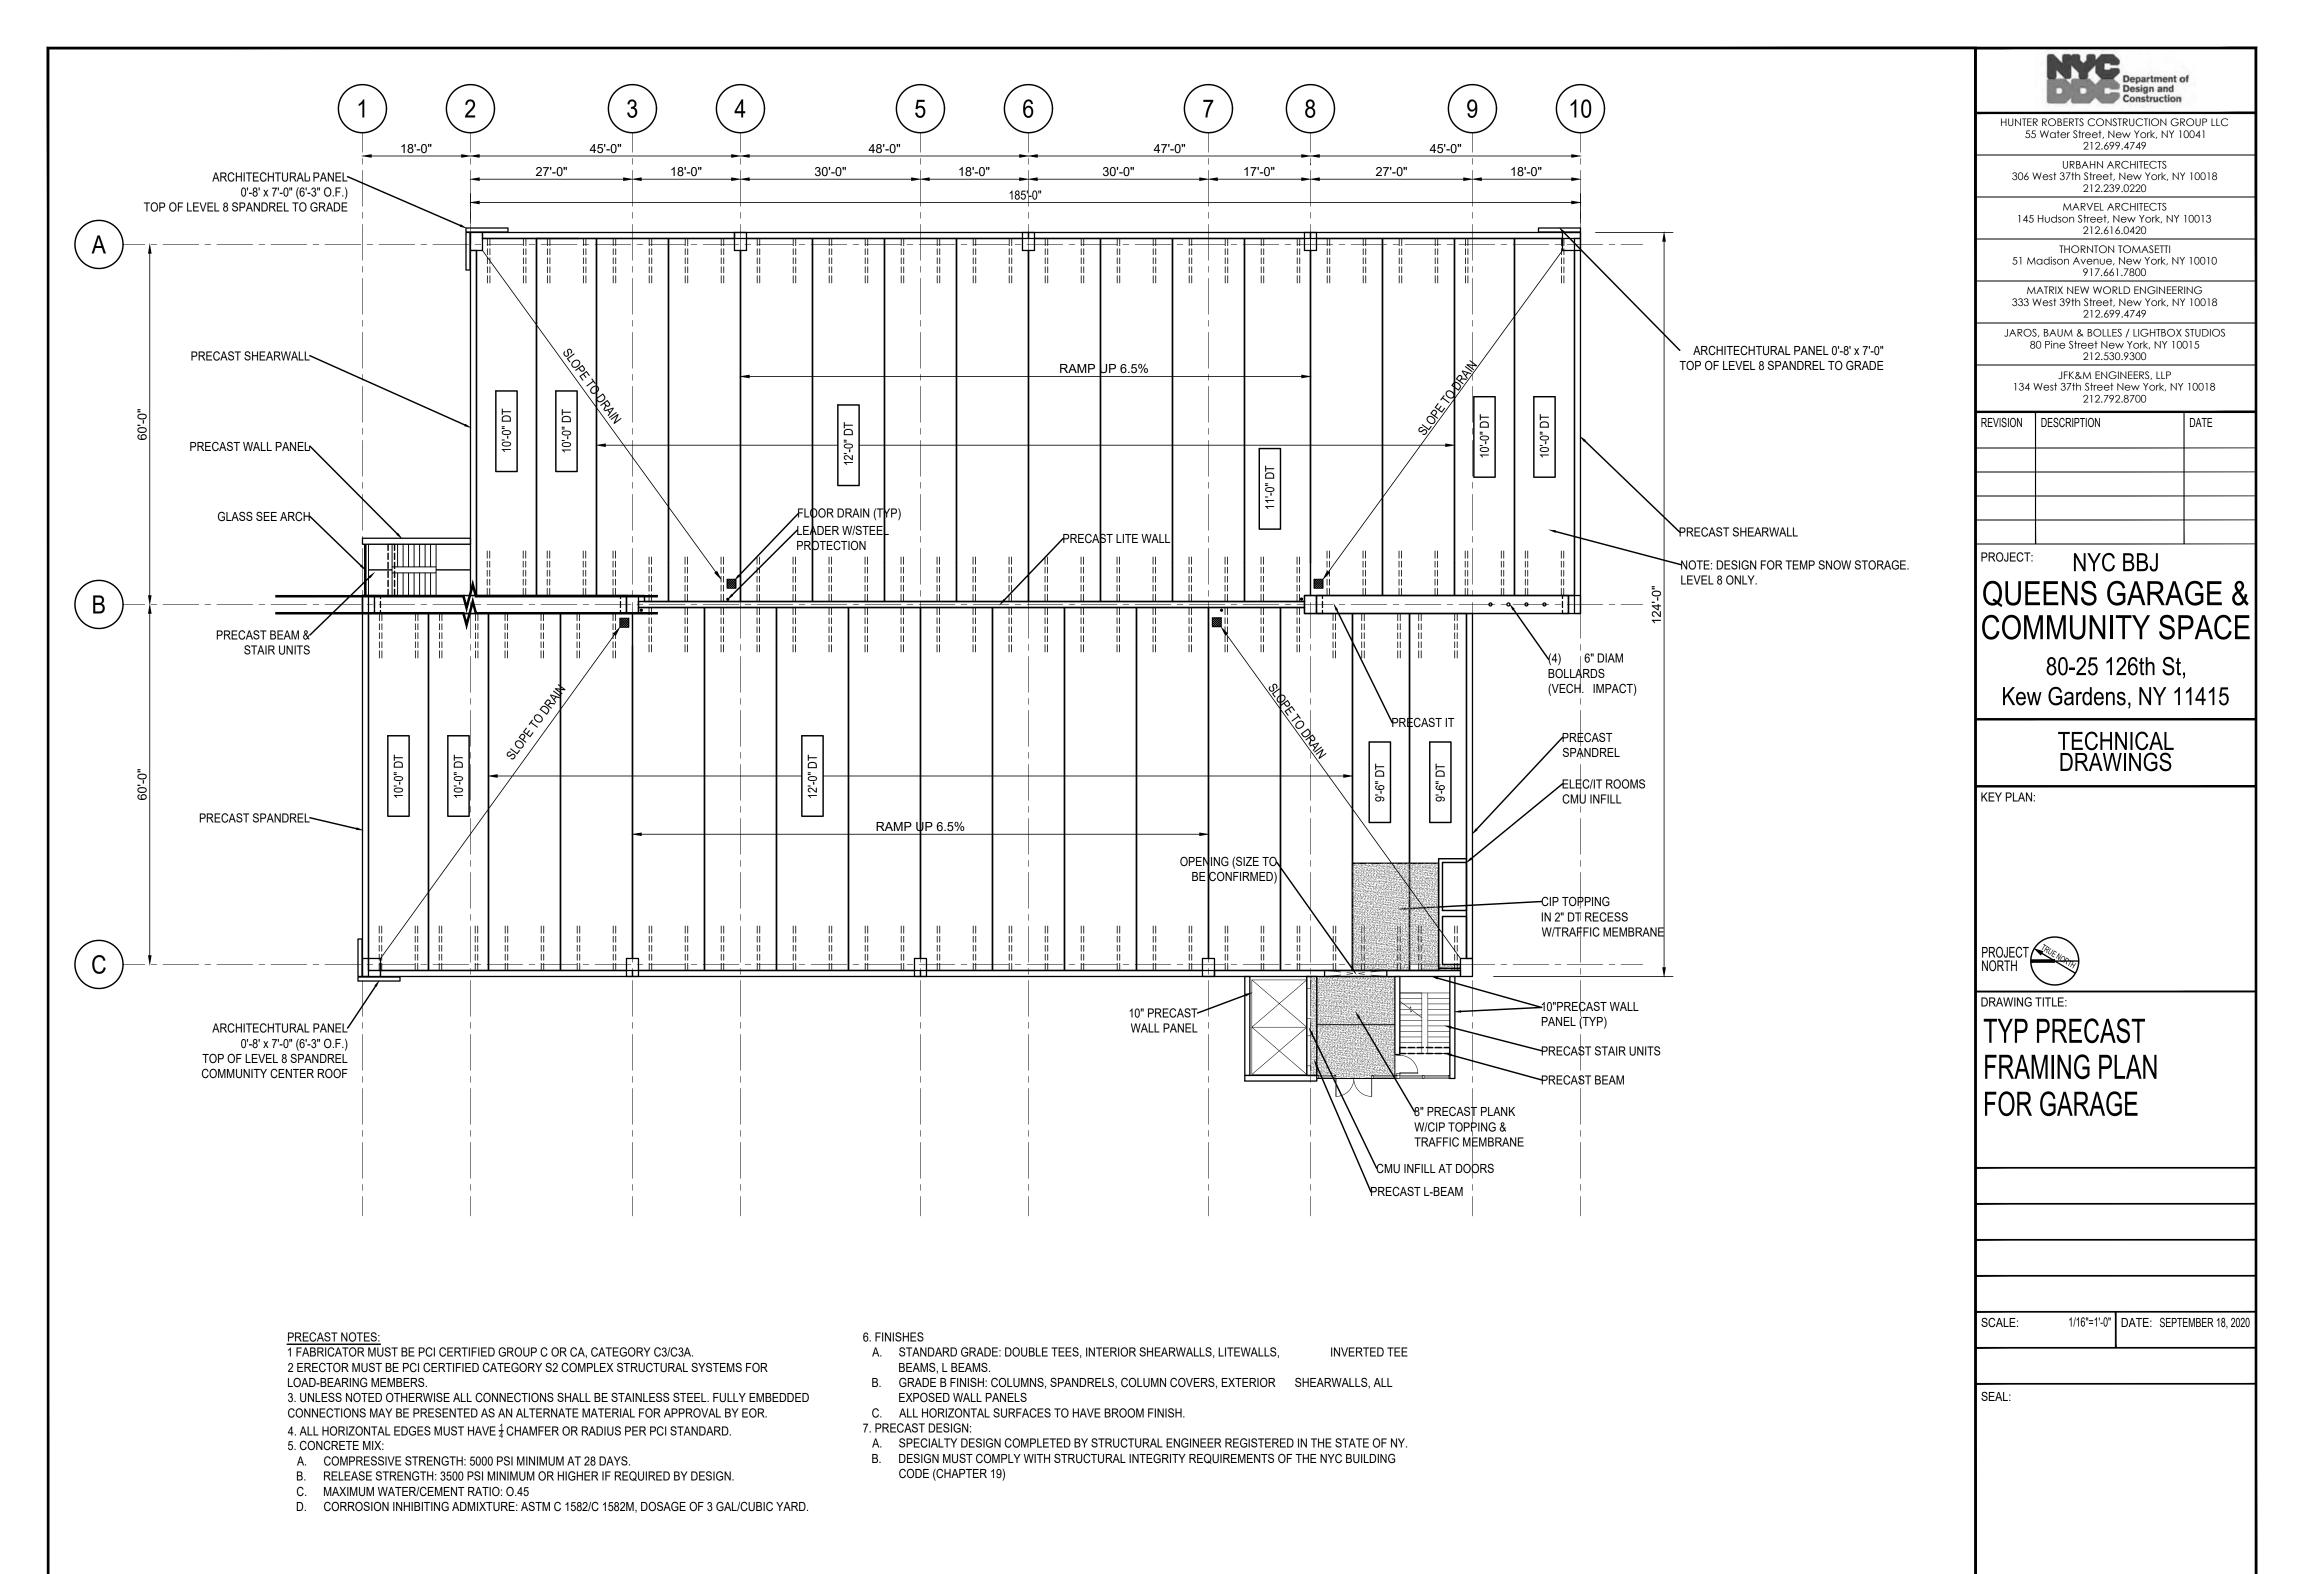
212.792.8700

DESCRIPTION

REVISION

DATE


51 Madison Avenue, New York, NY 10010





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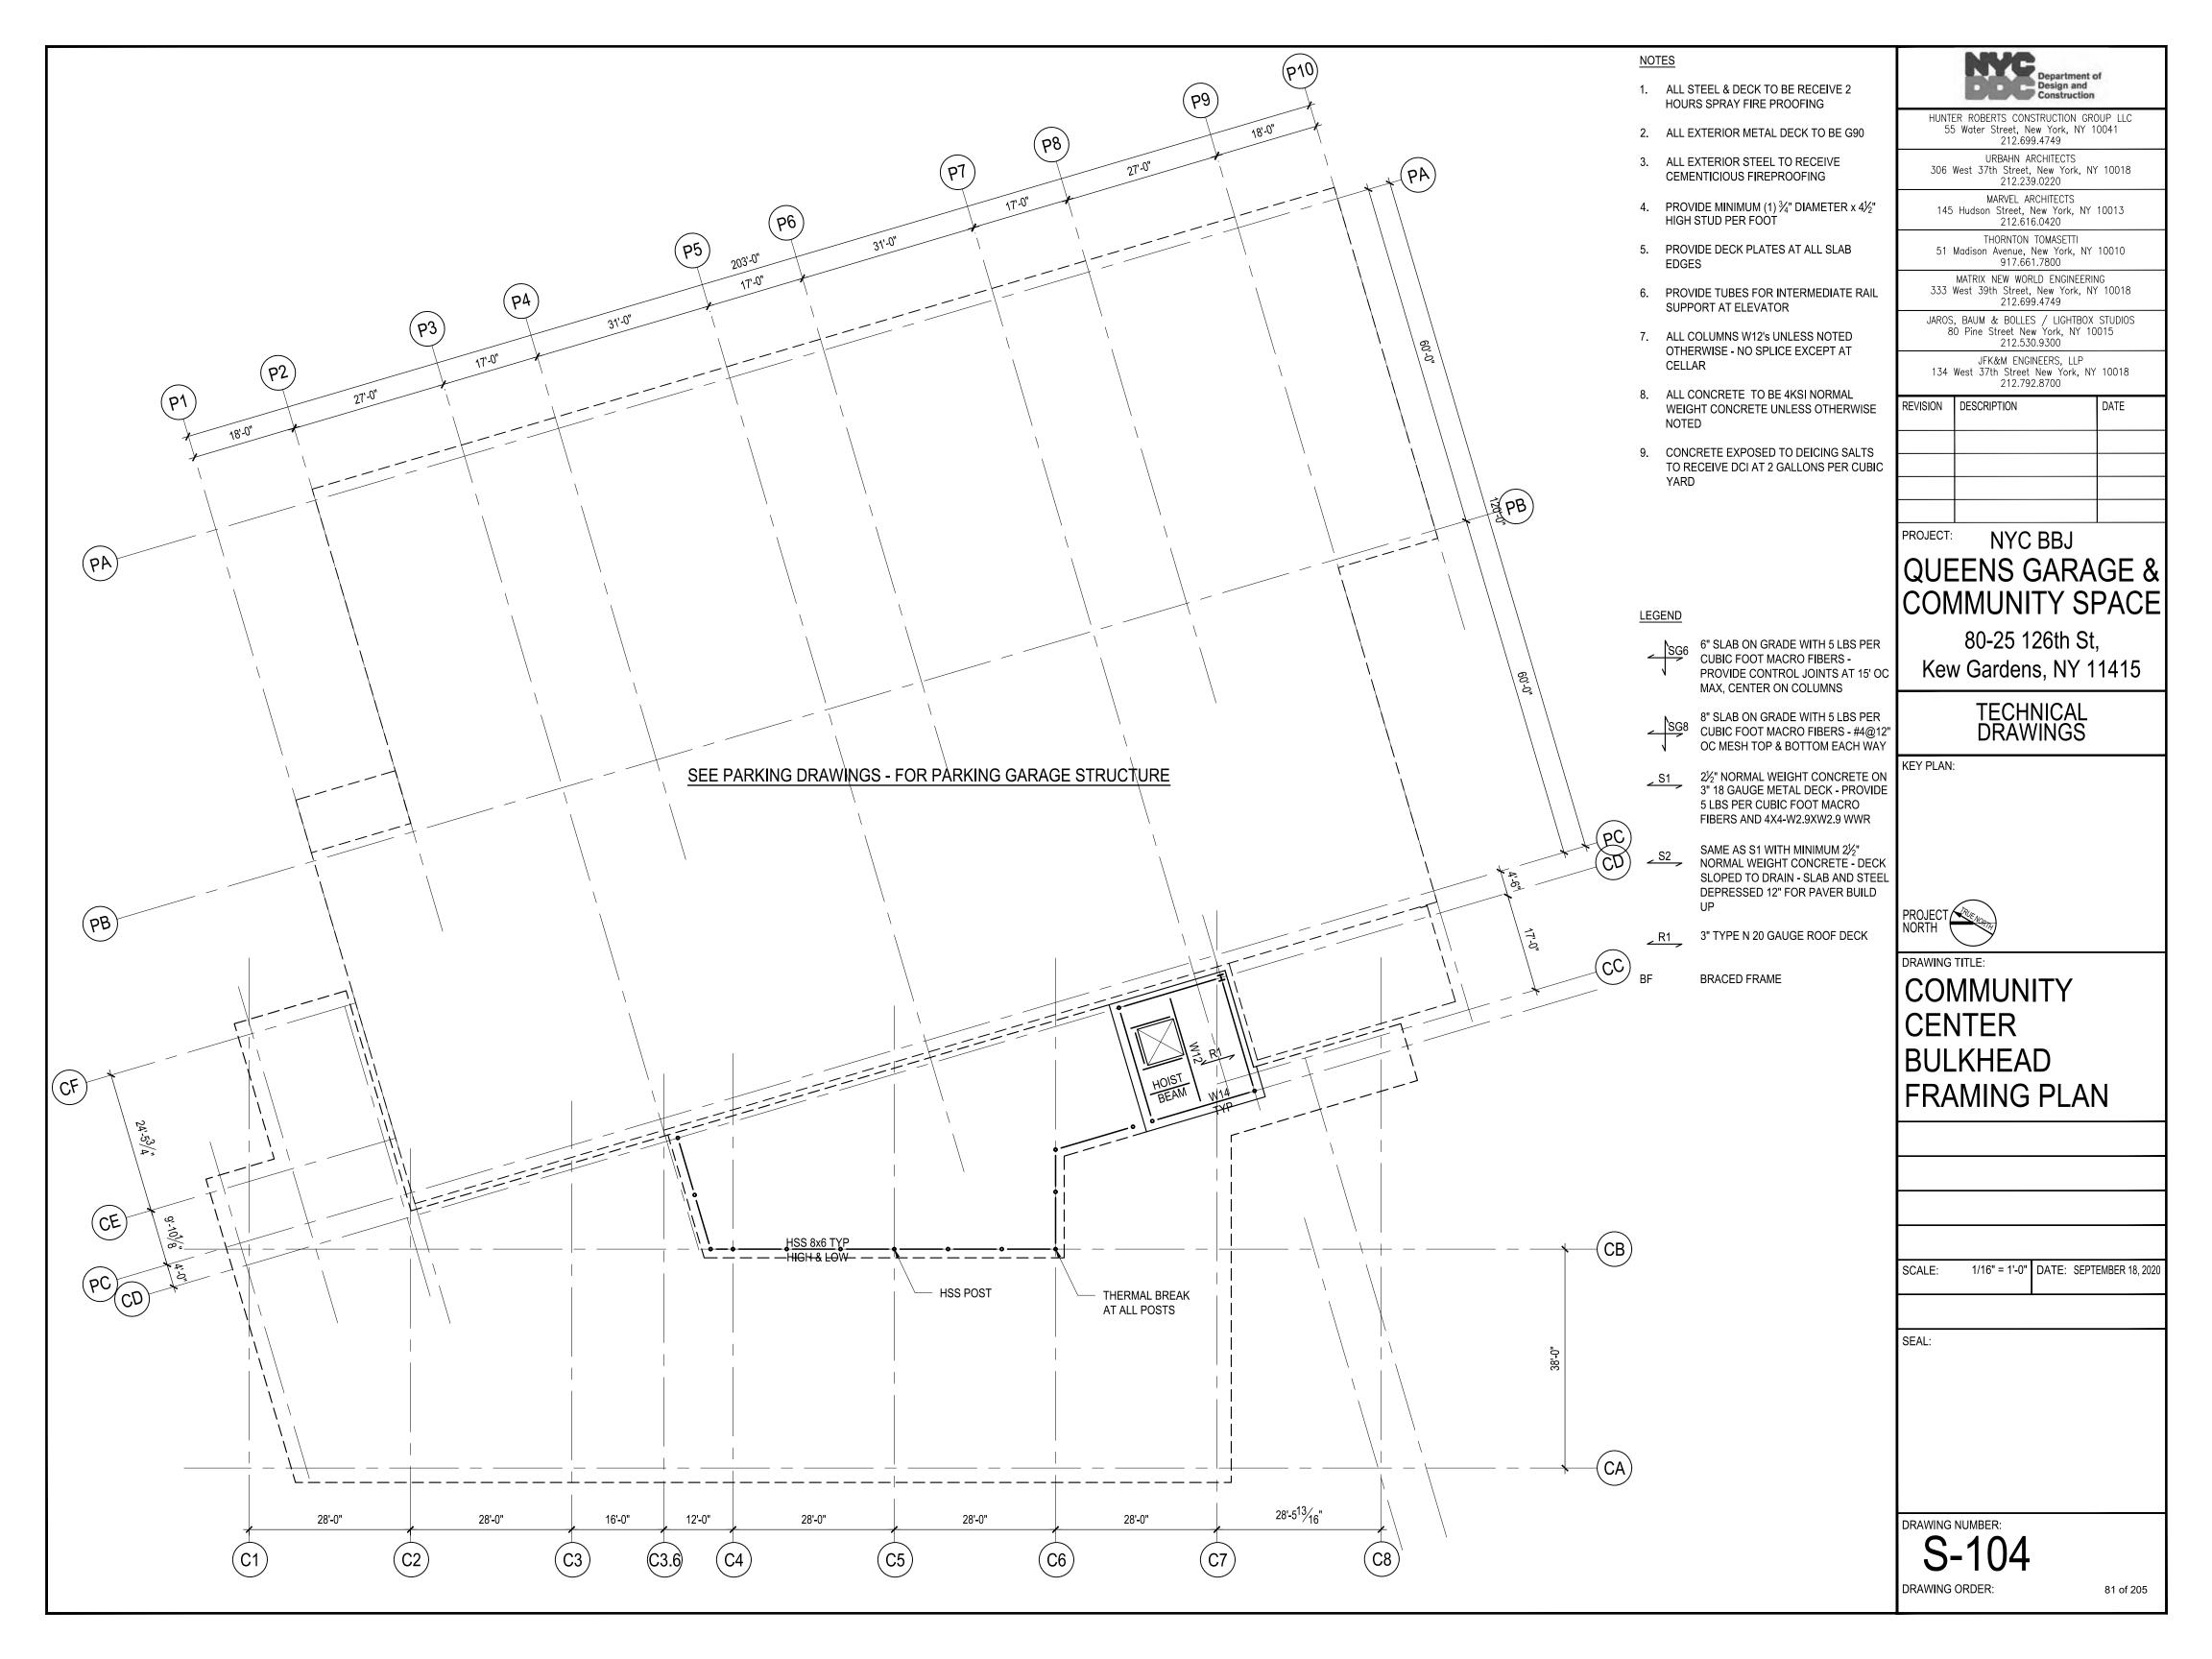
S-10


DRAWING ORDER:




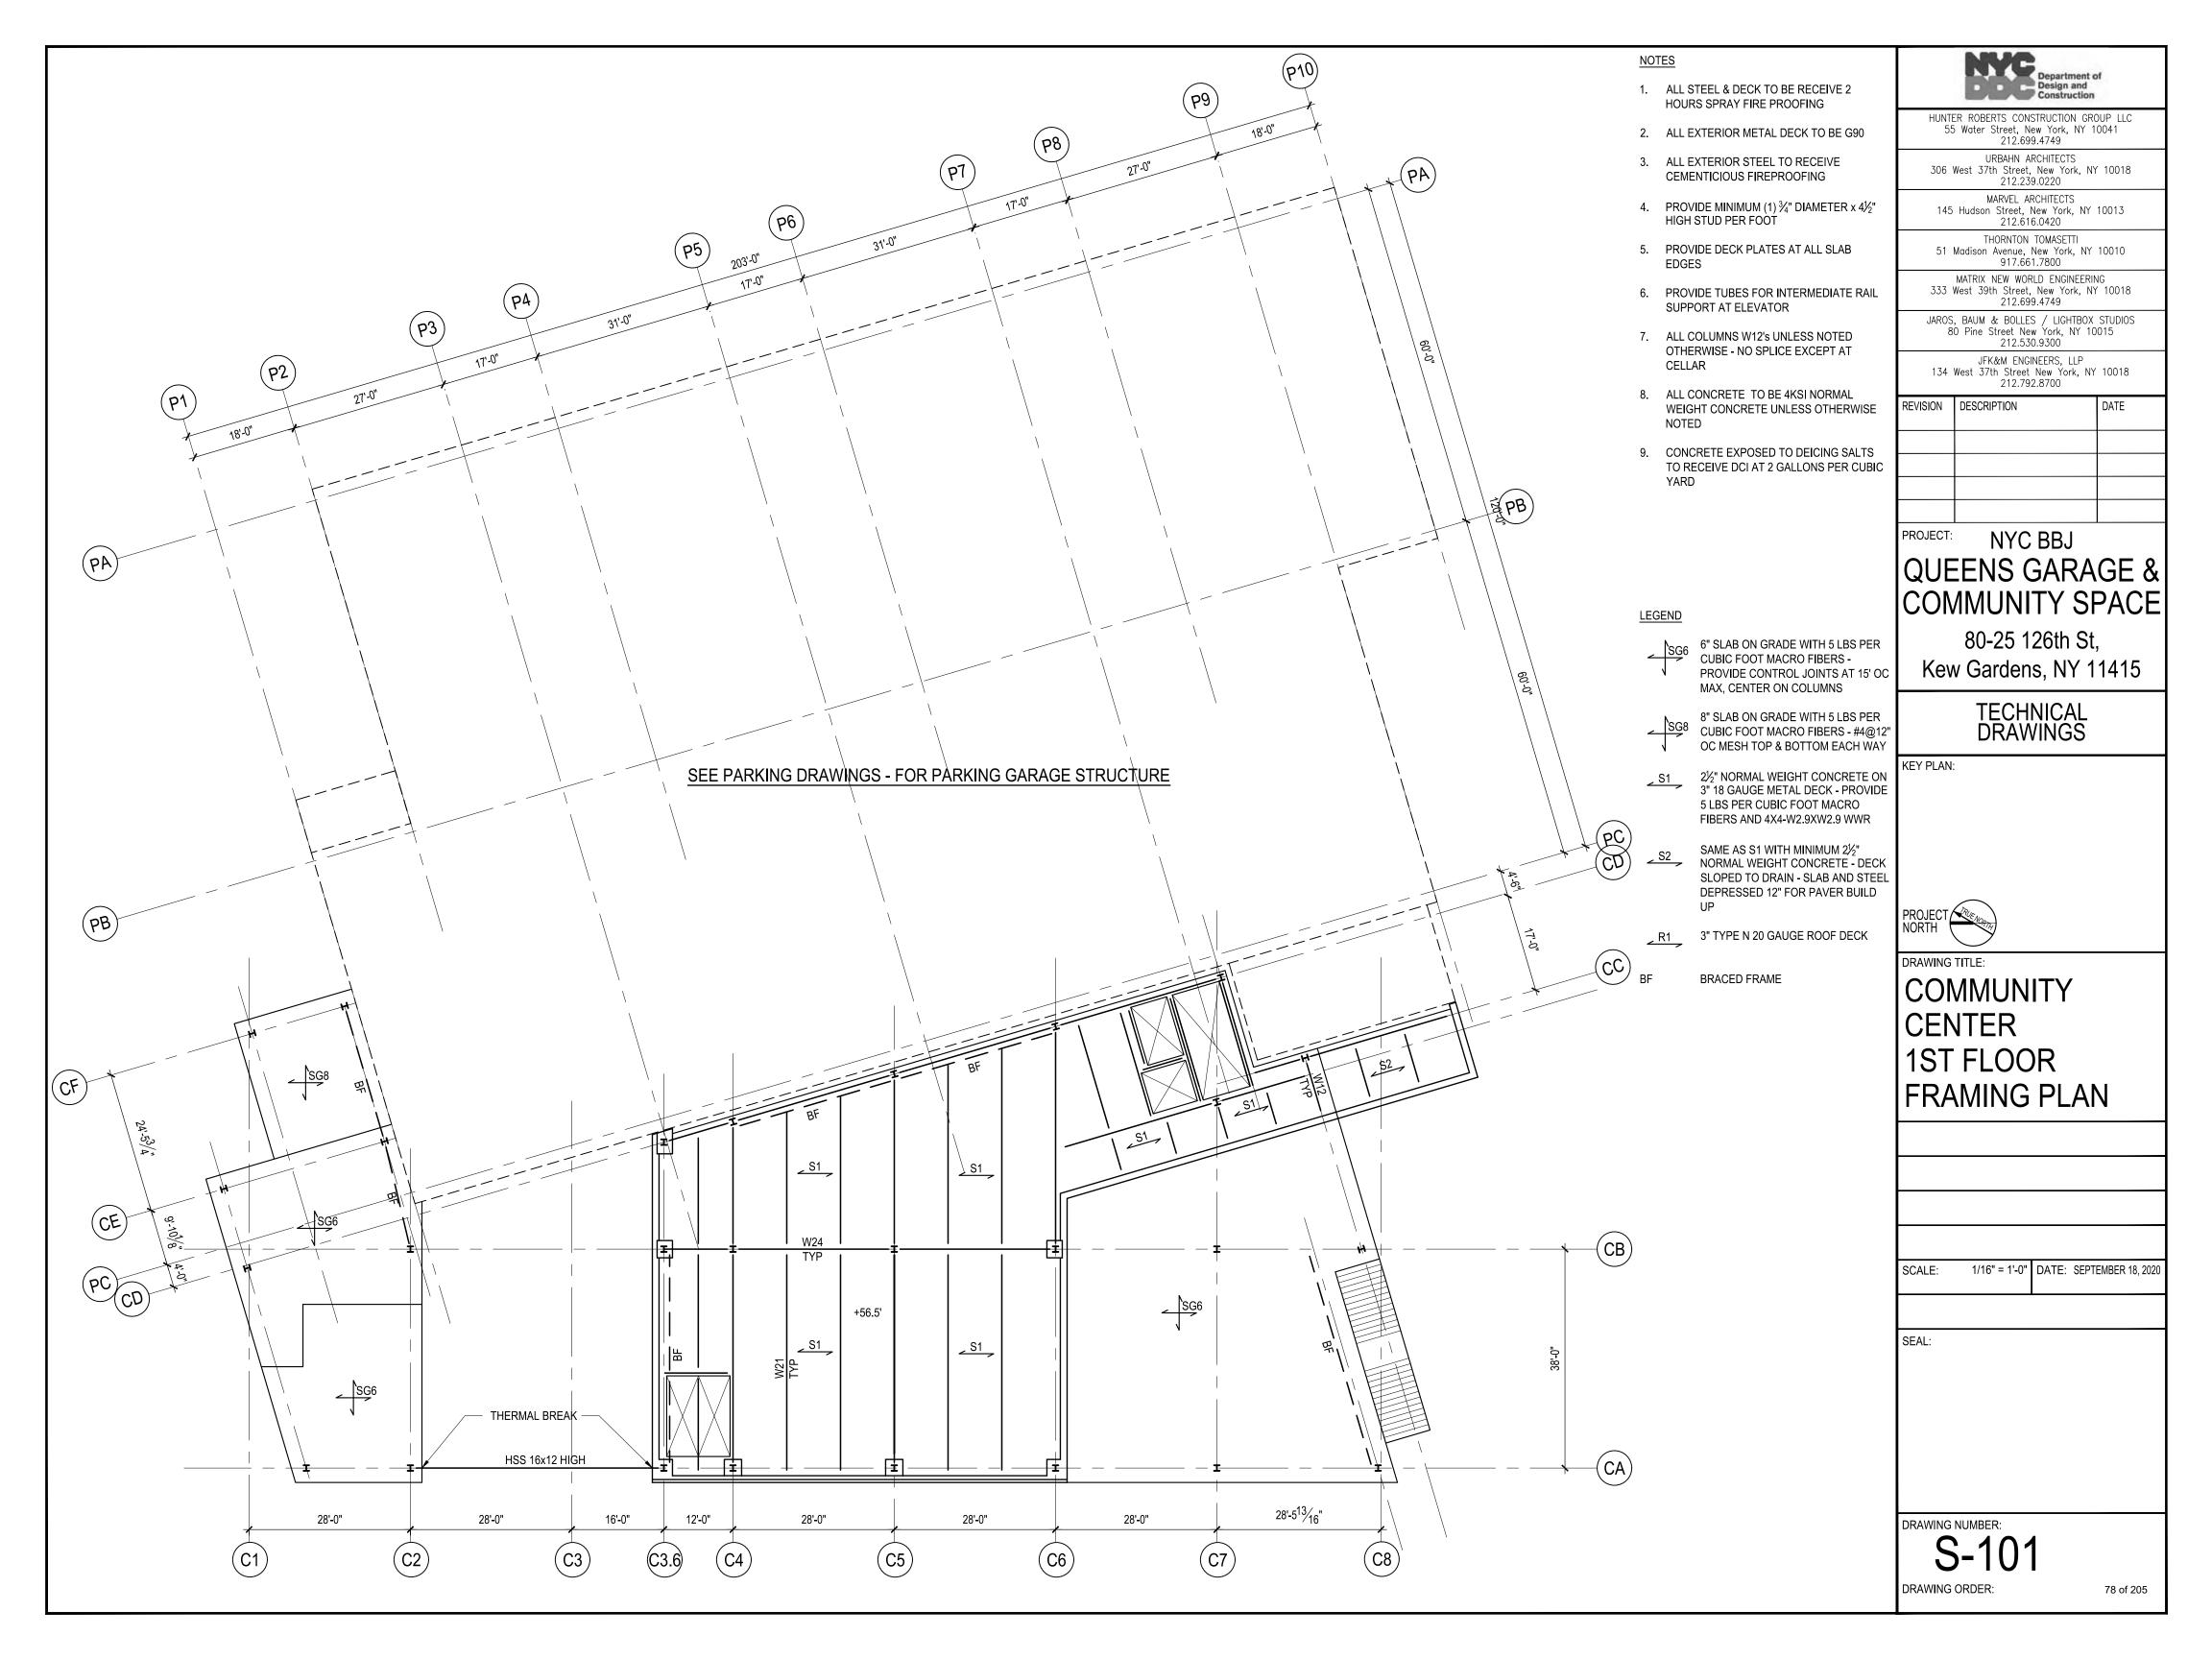

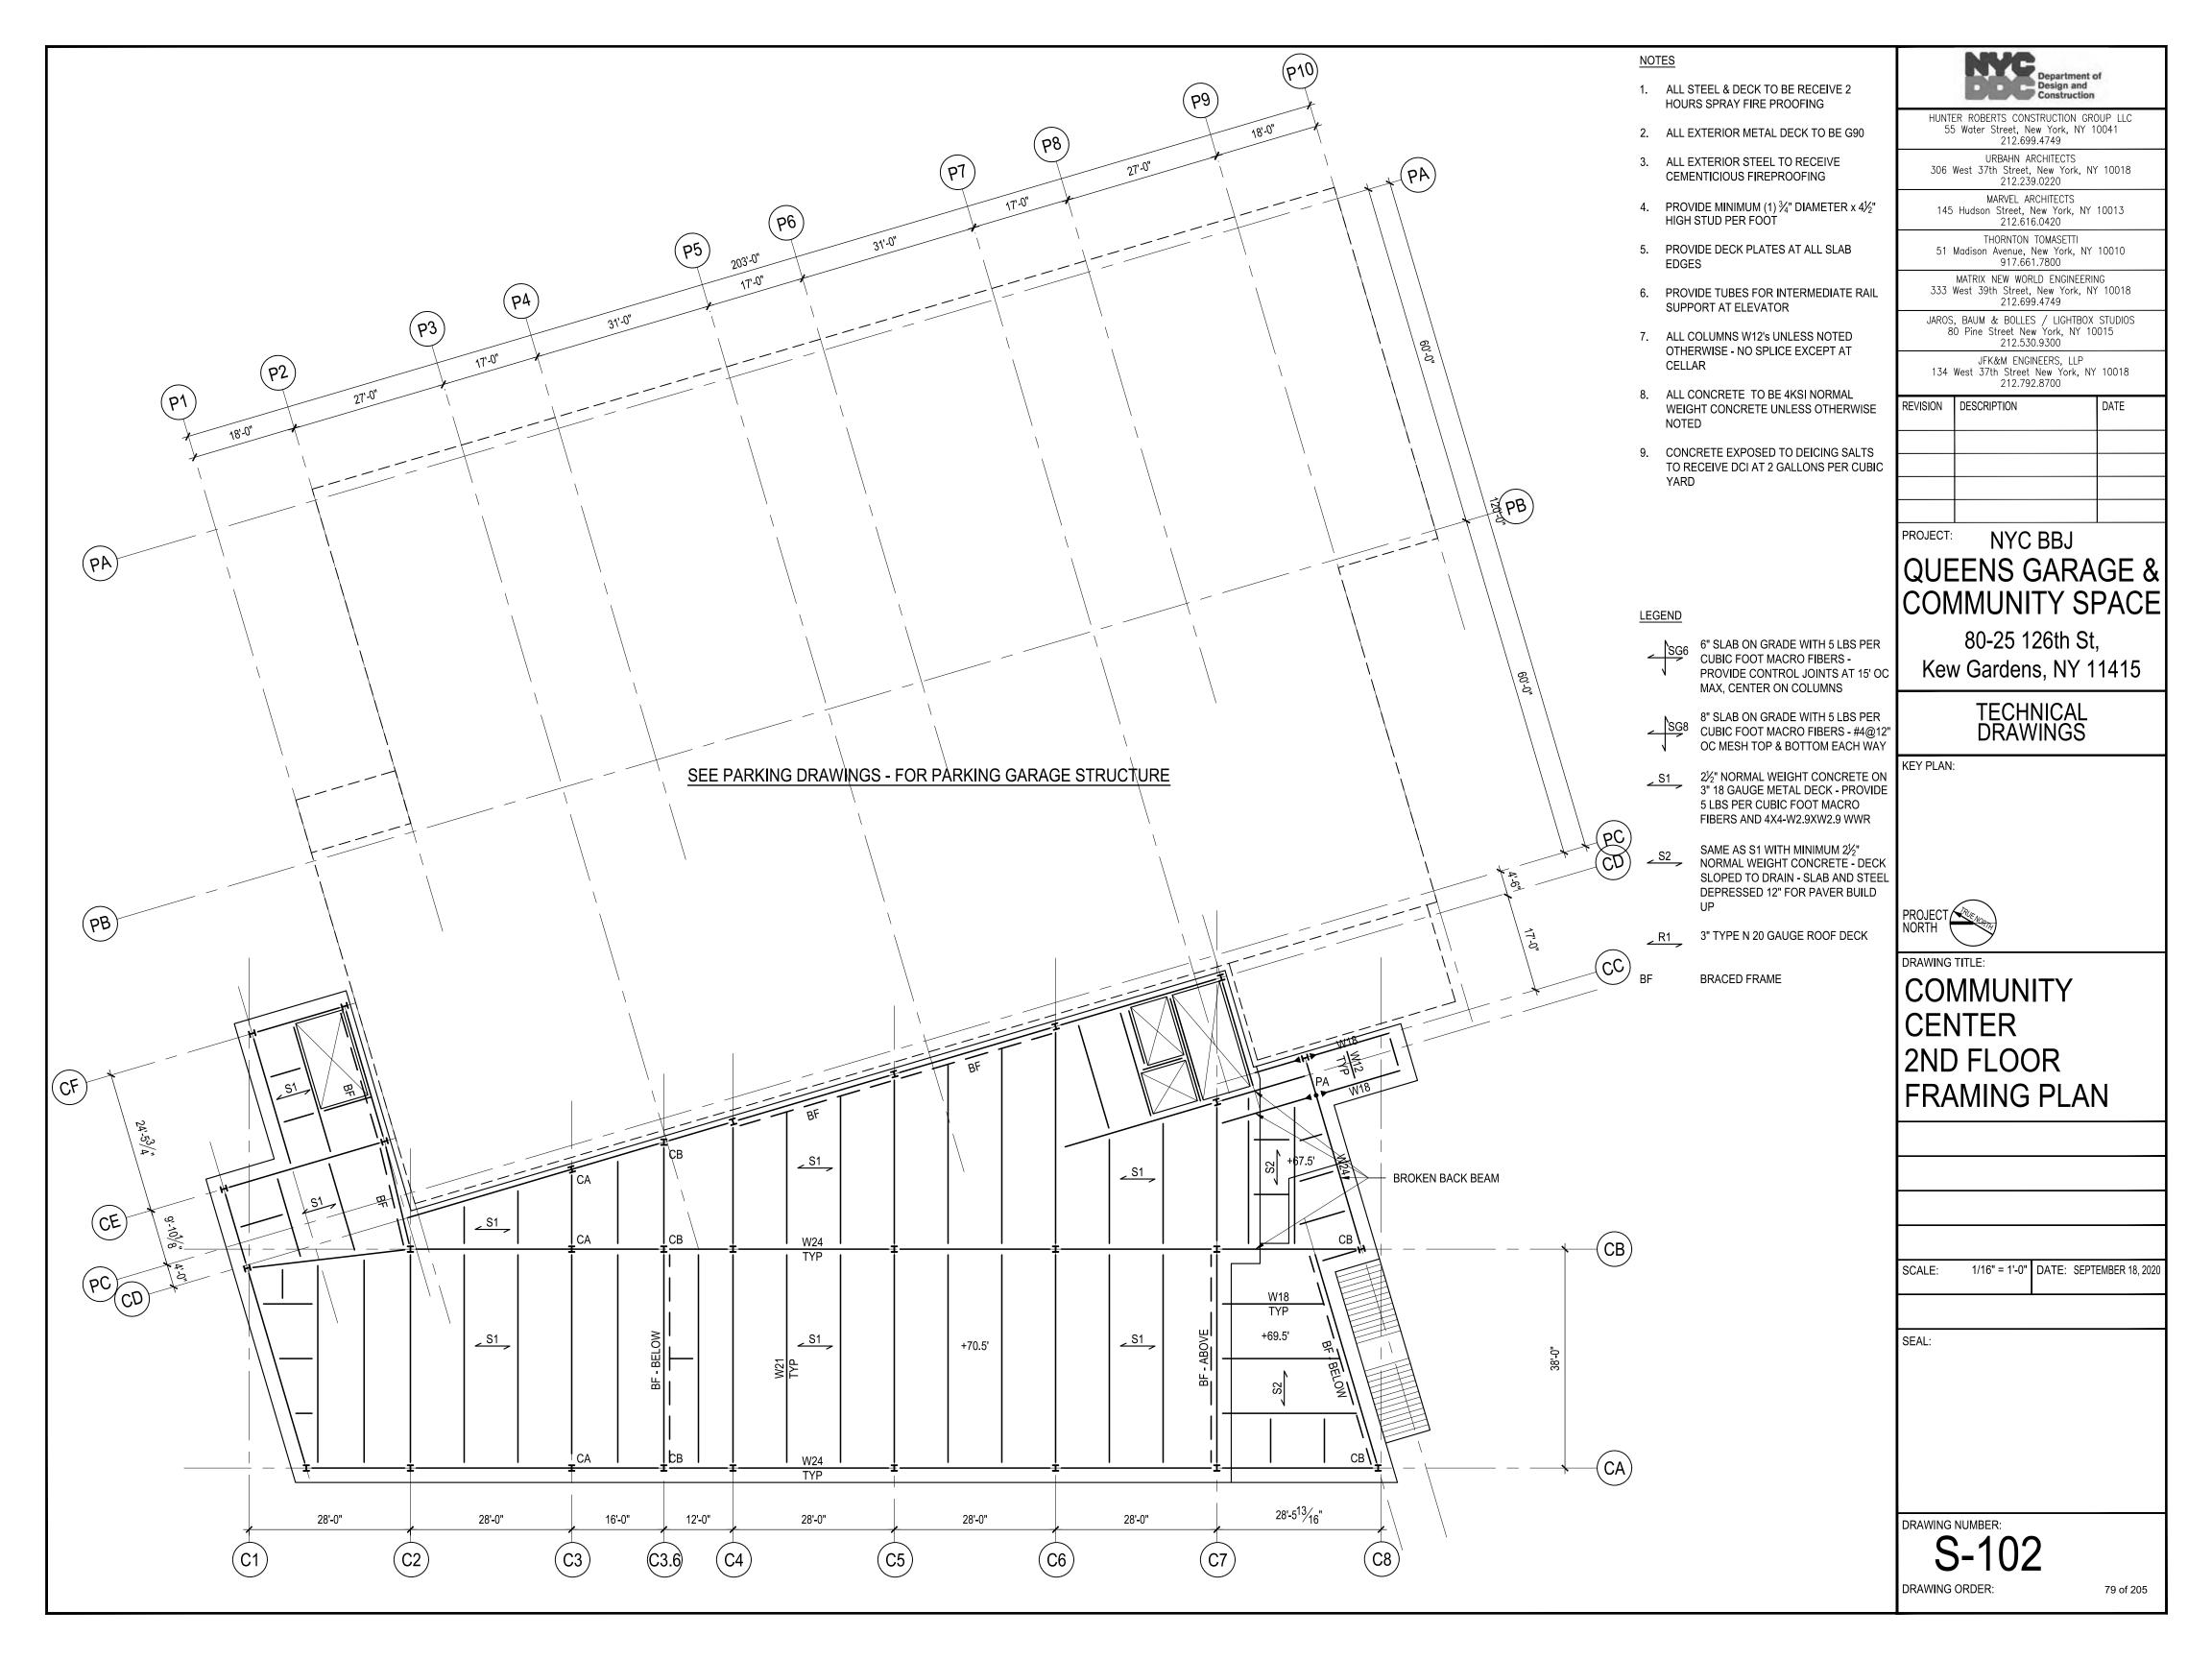

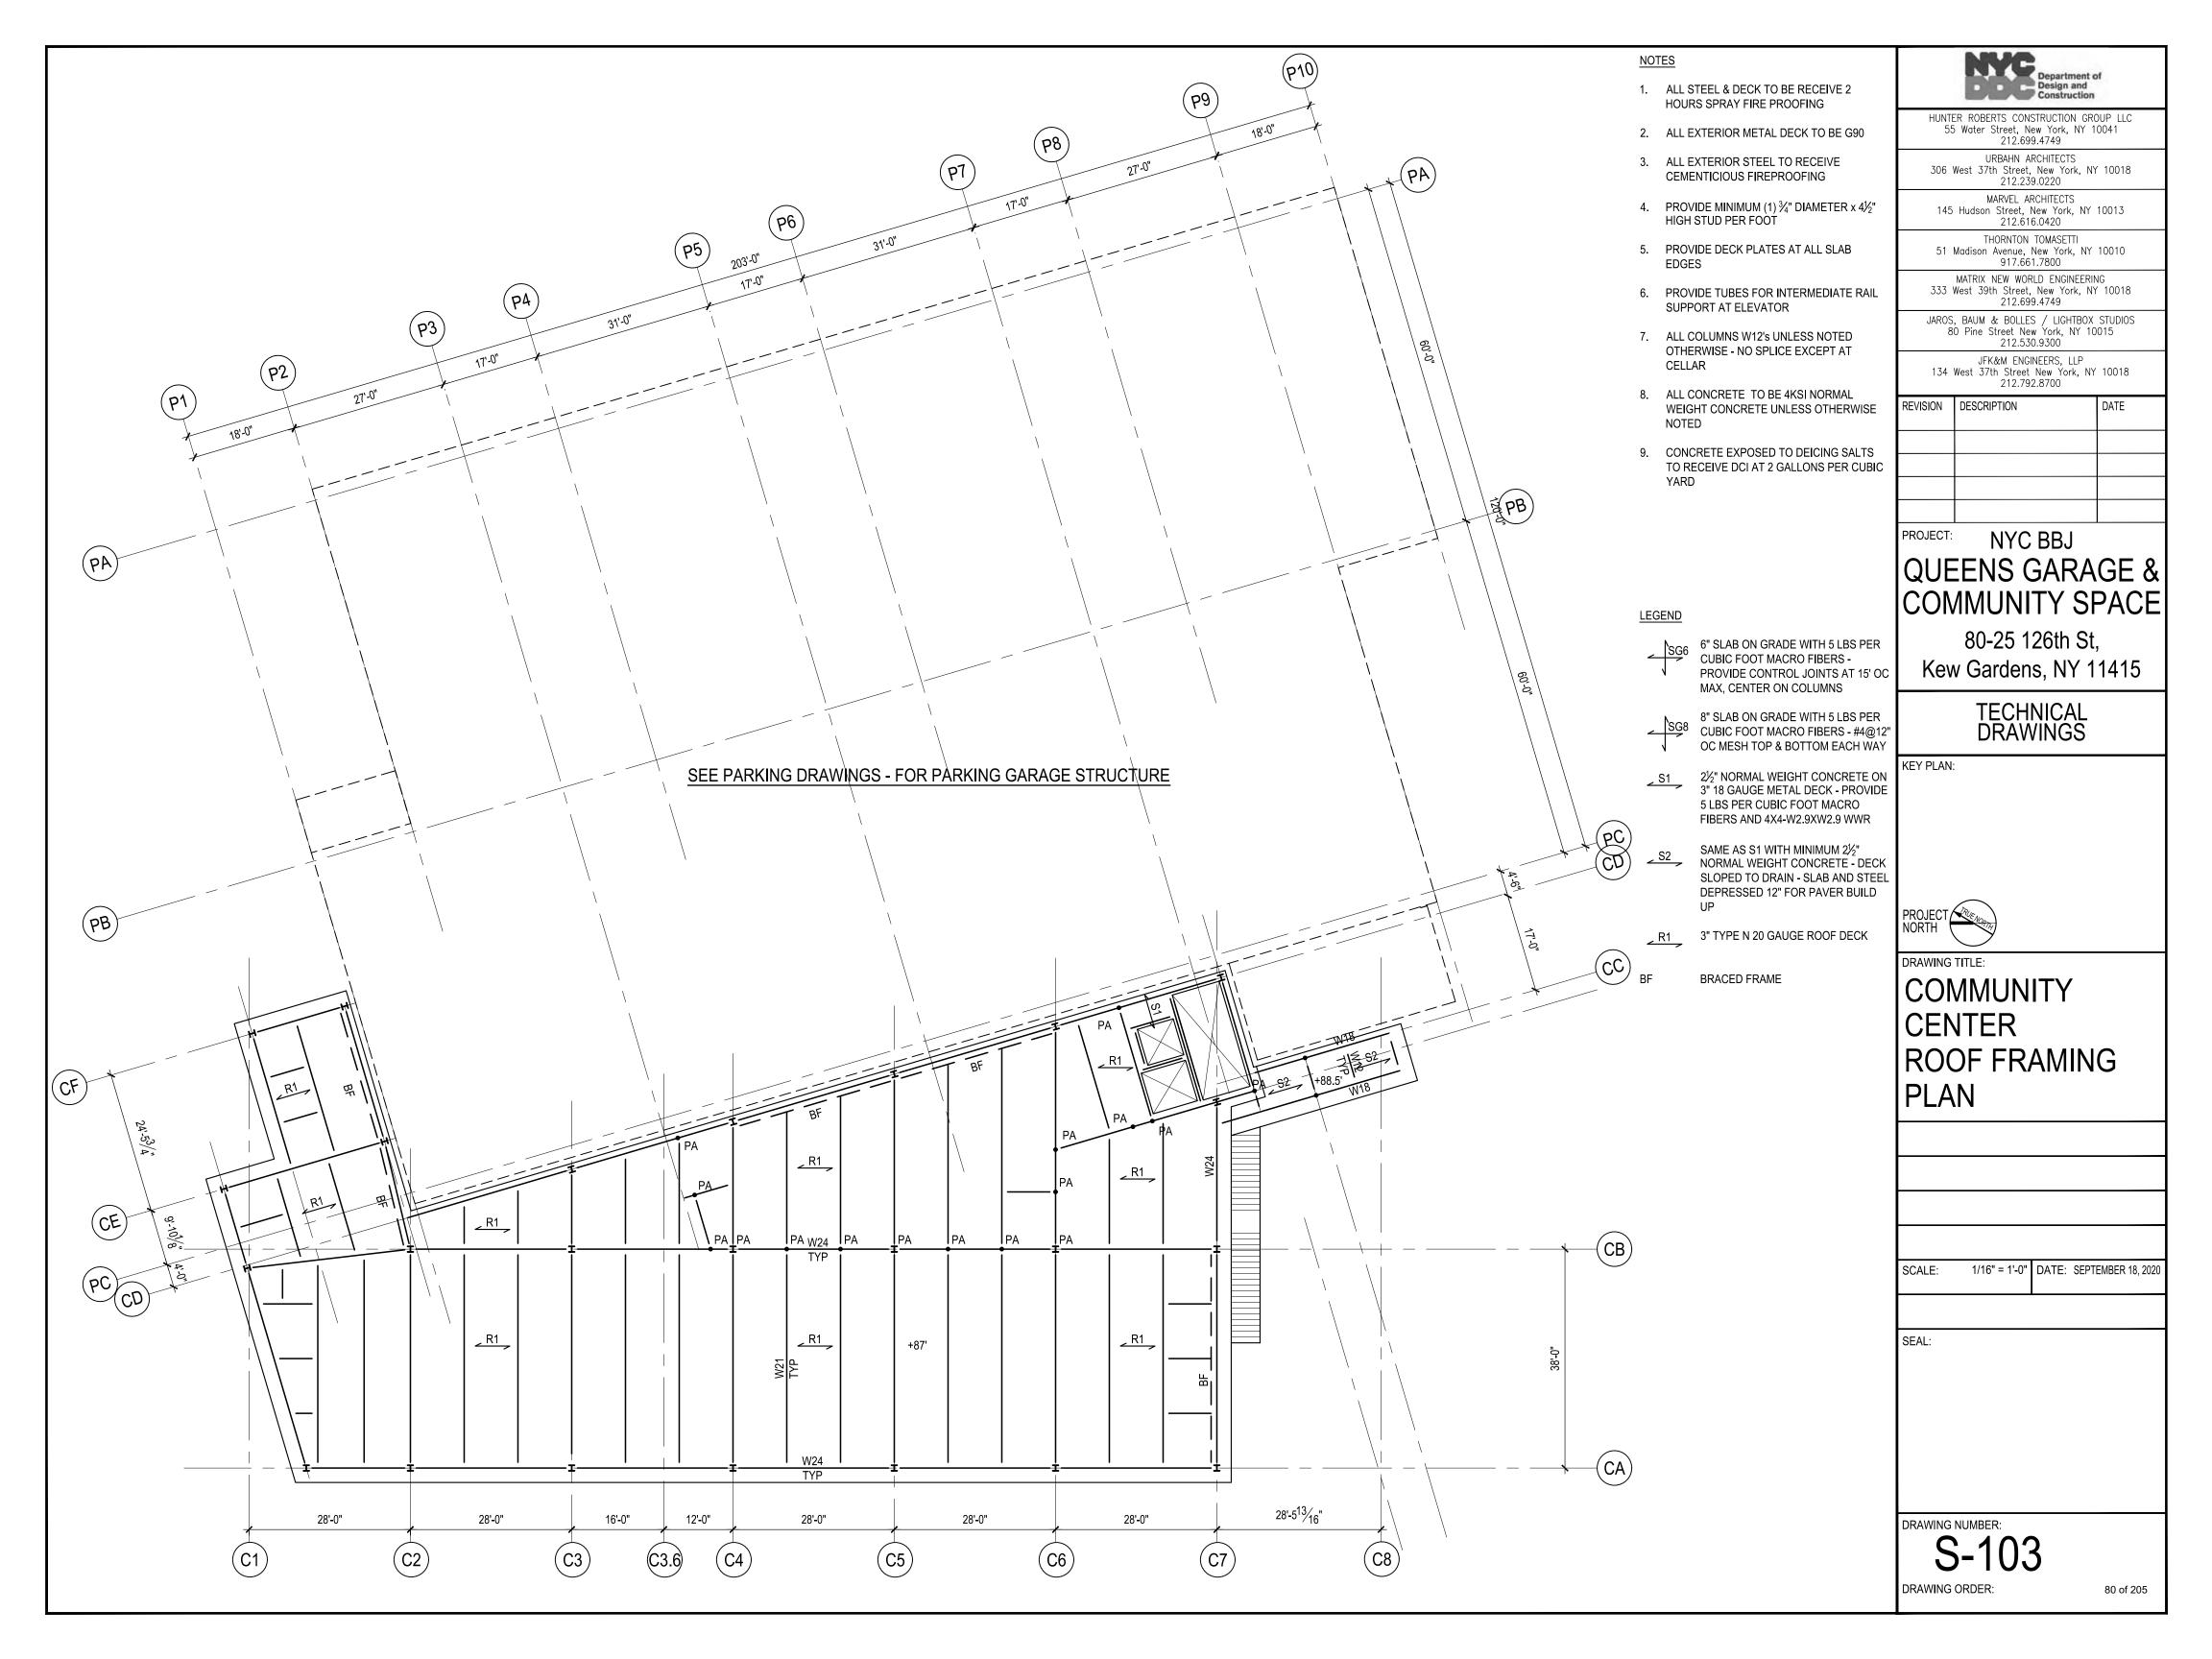

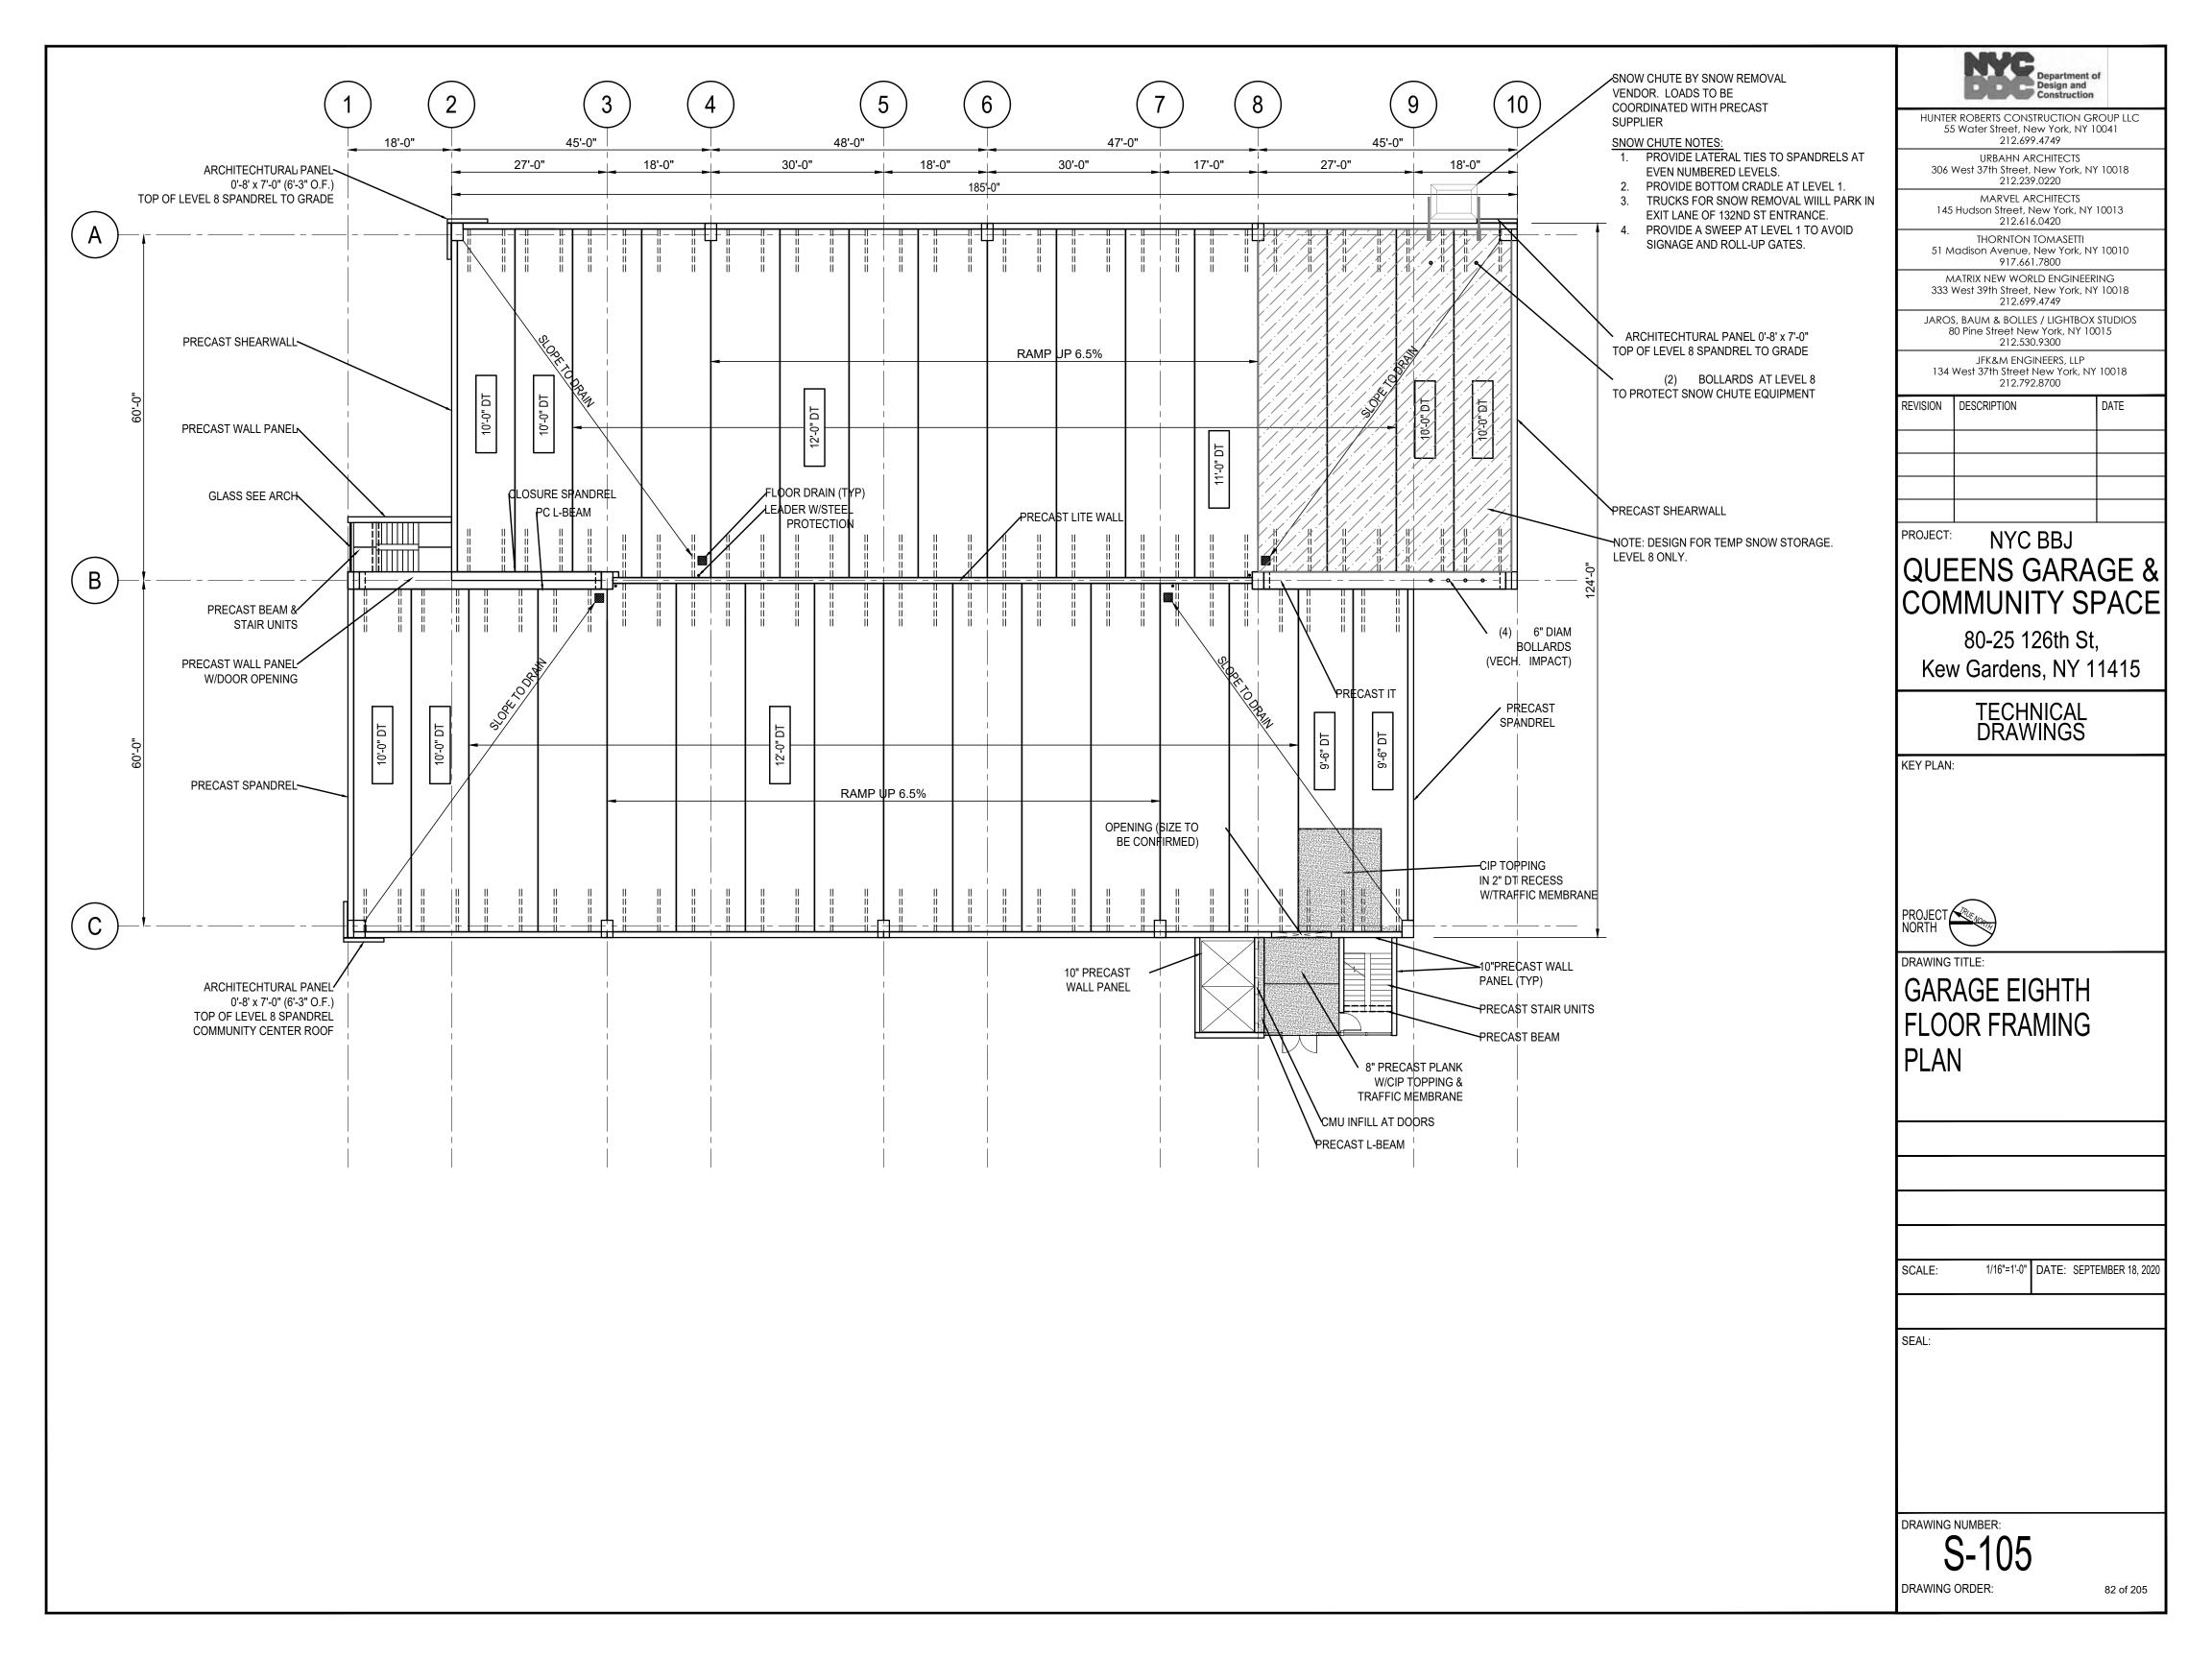

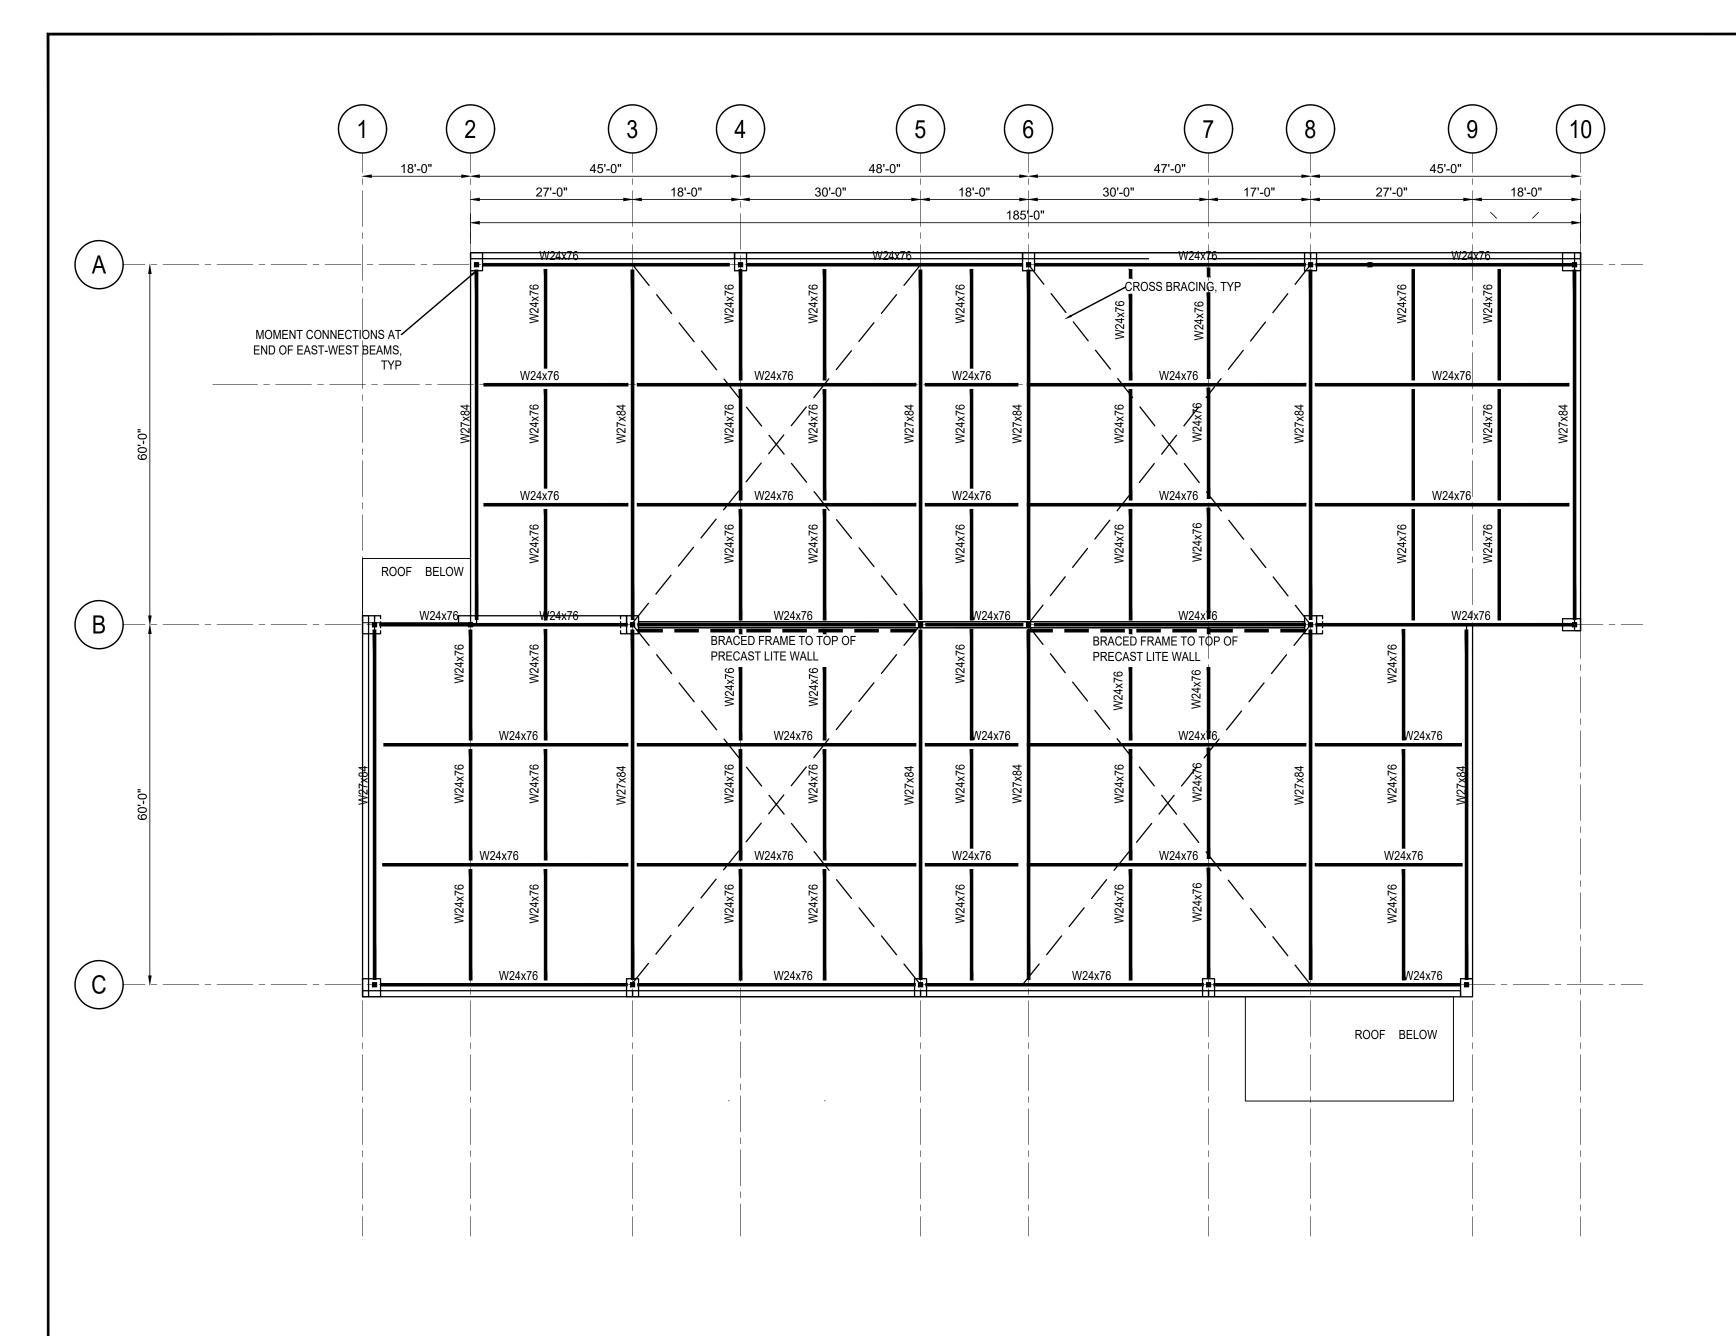

NOTES:

1. DUNNAGE AND CONNECTION OF PV PANELS BY PV PANEL SUPPLIER

2. ALL STEEL TO BE HOT DIP GALVANIZED



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REVISION	DESCRIPTION	DATE

JECT: NYC BBJ

QUEENS GARAGE & COMMUNITY SPACE

80-25 126th St, Kew Gardens, NY 11415

> TECHNICAL DRAWINGS



DRAWING TITLE:

GARAGE ROOF FRAMING PLAN


SCALE:	1/16"=1'-0"	DATE:	SEPTEMBER 18, 2

SEAL:

DRAWING NUMBER:


S-106

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REVISION	DESCRIPTION	DATE
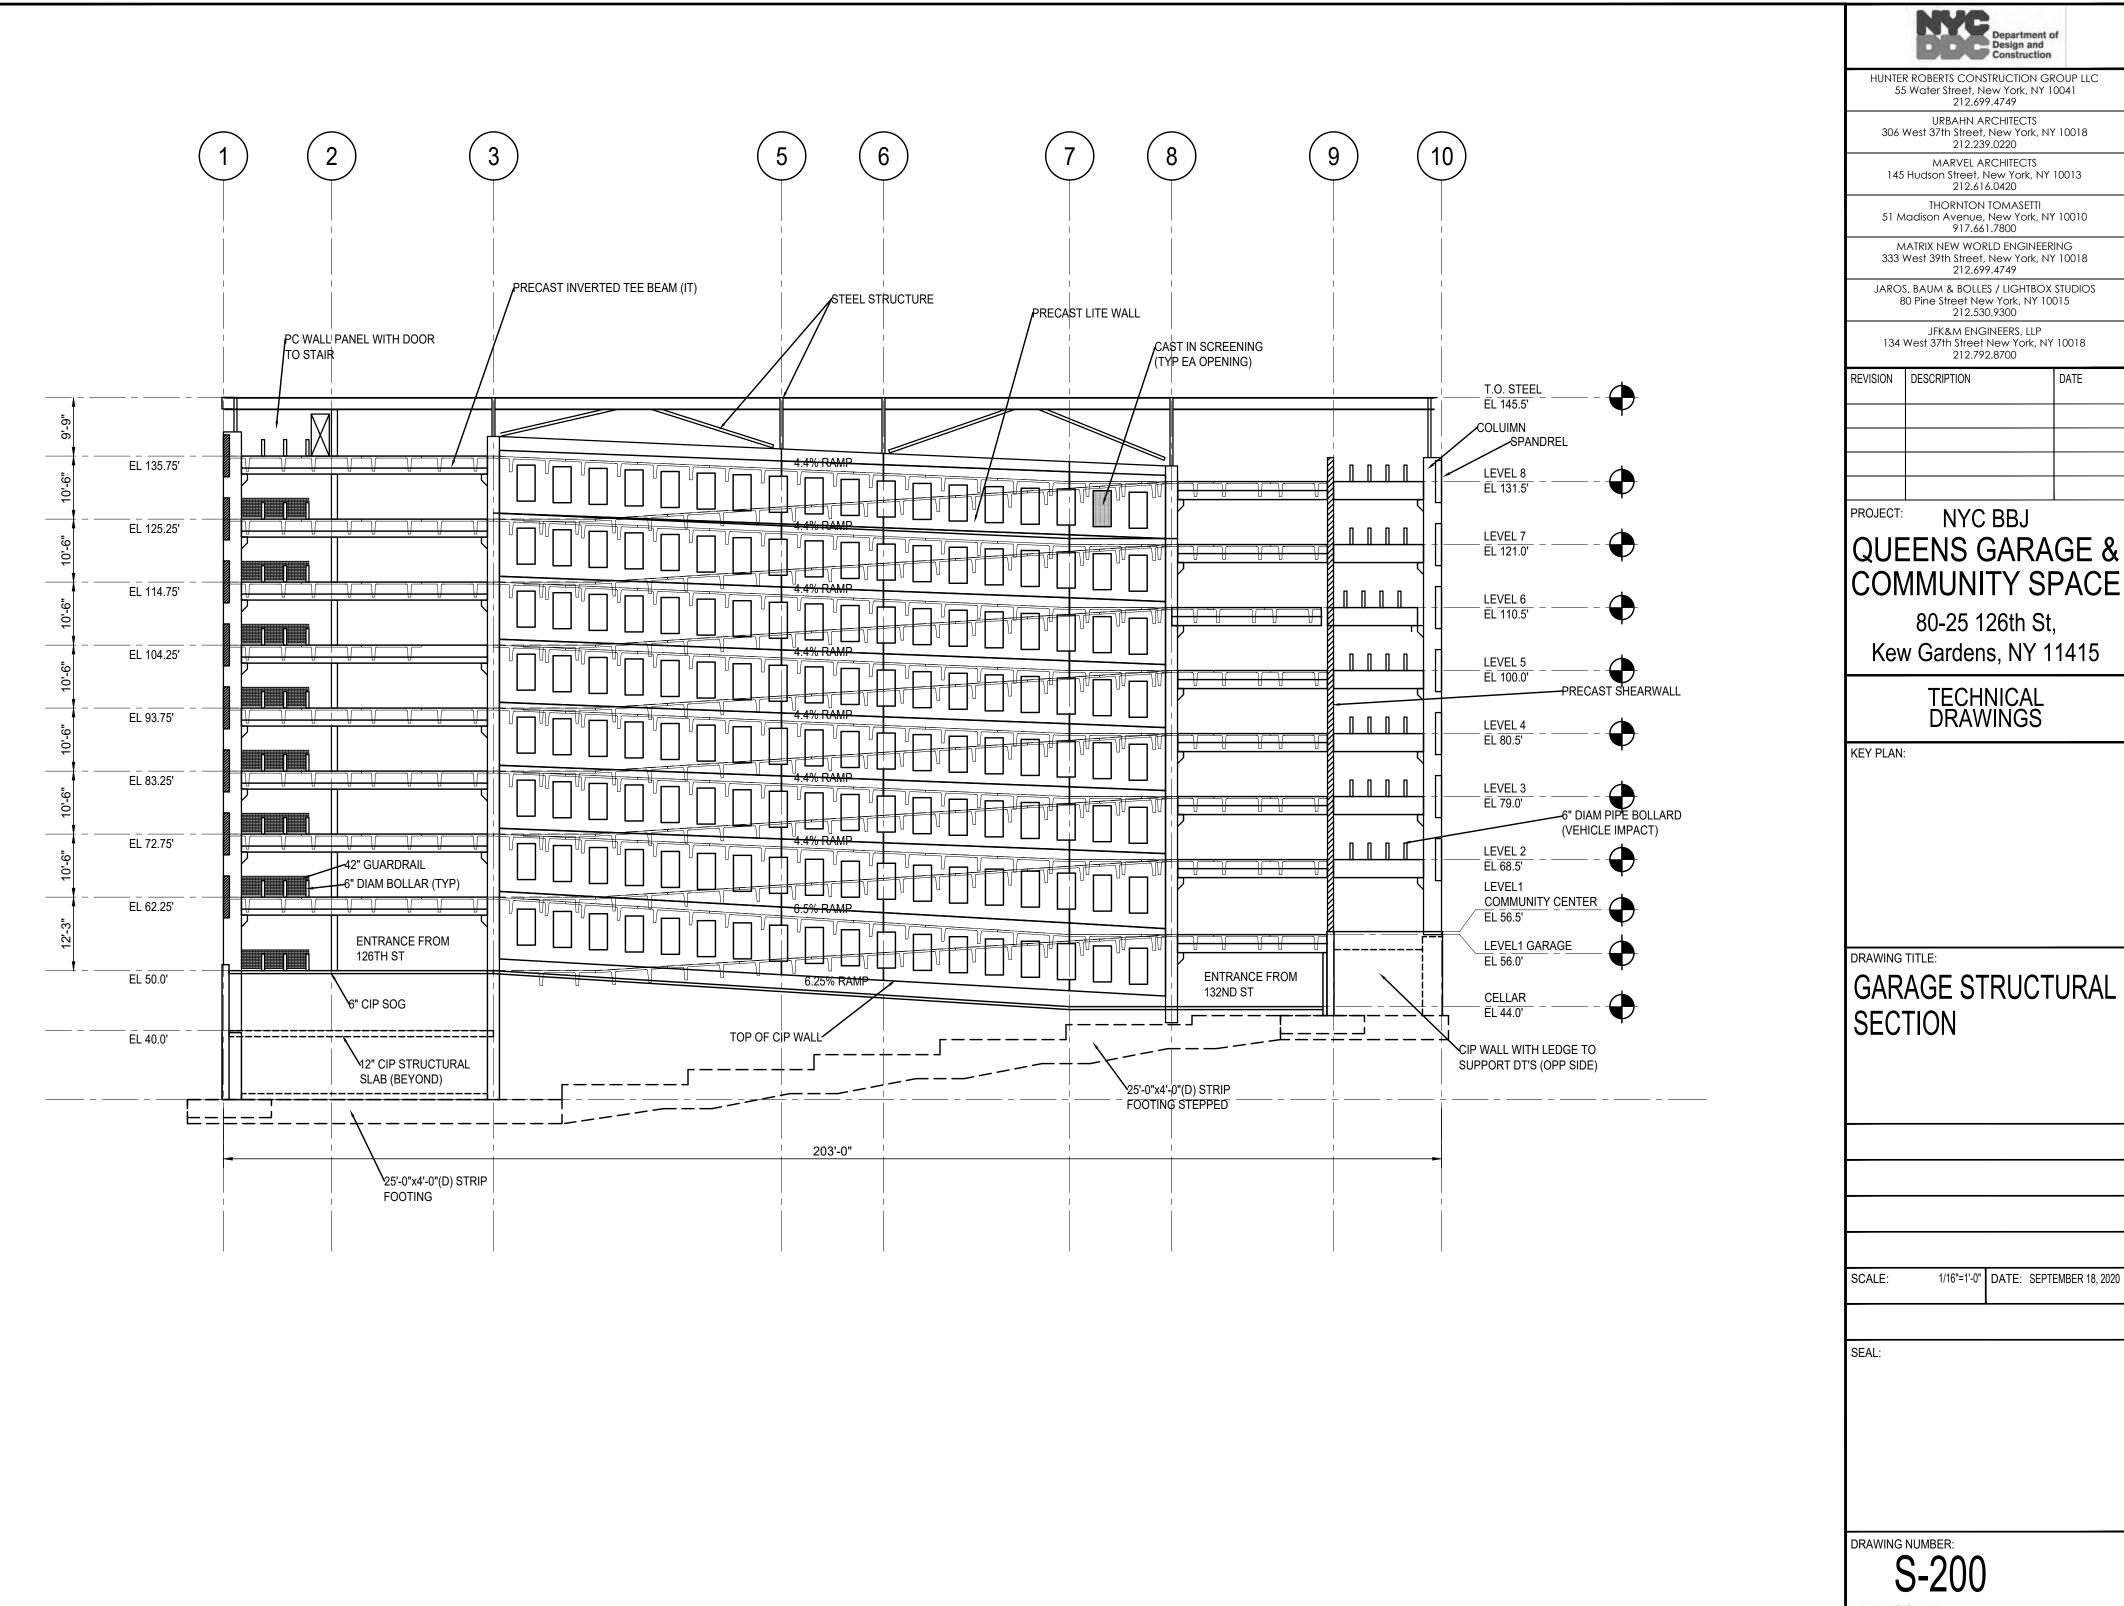
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Department of Design and Construction

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REVISION DESCRIPTION DATE

OJECT: NYC BBJ

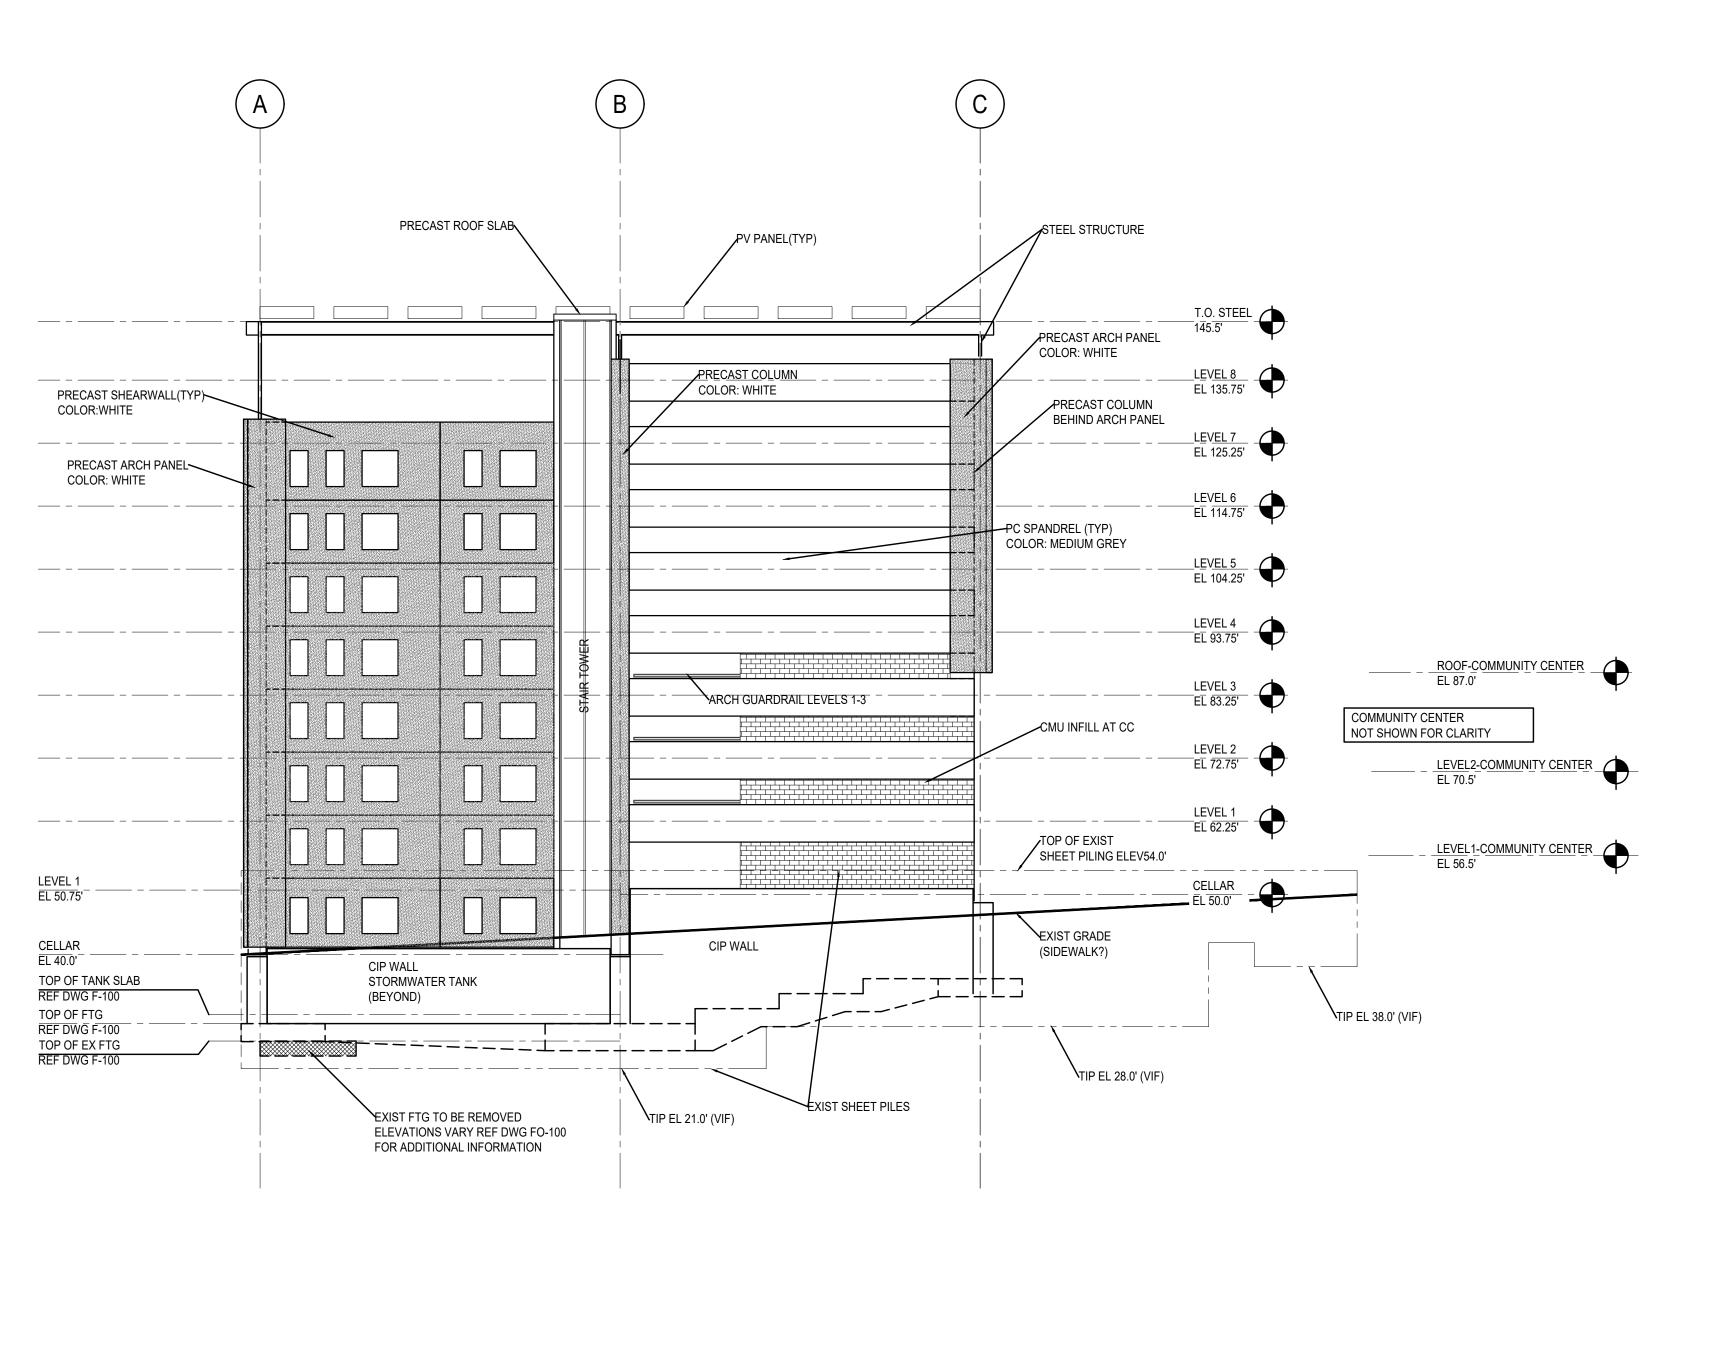QUEENS GARAGE & COMMUNITY SPACE

80-25 126th St, Kew Gardens, NY 11415

TECHNICAL DRAWINGS

DRAWING TITLE:

KEY PLAN:

GARAGE NORTH ELEVATION

SCALE: 1/16"=1'-0" DATE: SEPTEMBER 18, 2020

SEAL:

DRAWING NUMBER:

S-300

DRAWING ORDER:

